
KINGDOM OF THE HAWK - TASTING ROOM SITE DEVELOPMENT PLANS

113 PENDLETON HILL AVENUE MAP 122 LOT 2660 NORTH STONINGTON, CONNECTICUT

ISSUED FOR PERMITTING

PREPARED FOR KINGDOM OF THE HAWK, LLC

DATE ISSUED: MAY 6, 2021

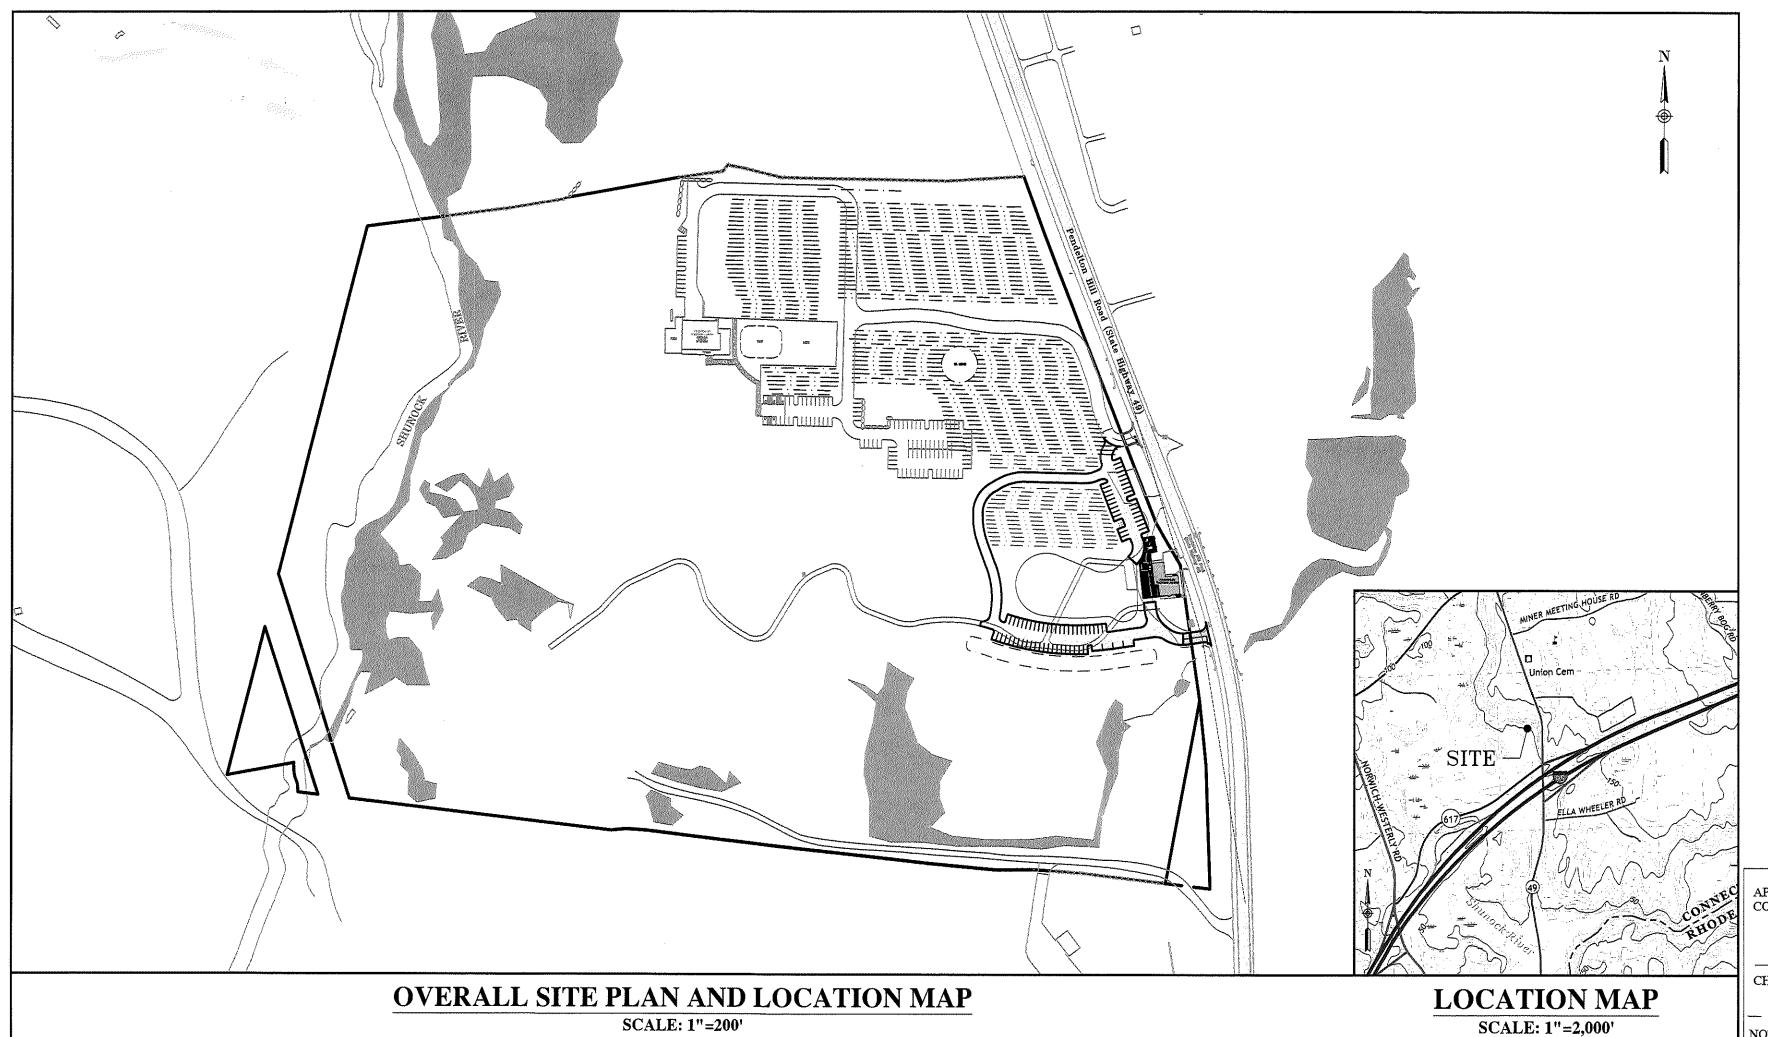

APPROVED BY THE NORTH STONINGTON PLANNING AND ZONING CHAIRMAN / SECRETARY SITE PLAN APPROVED BY THE NORTH STONINGTON PLANNING AND

Civil Engineers Land Surveyors Land Use Planners

Environmental Engineers

CHERENZIA & ASSOCIATES, LTD. Pawcatuck, CT 06379 Tel: 860.629.6500 Fax: 860.599.6090

www.cherenzia.com

P.O. Box 513

Westerly, RI 02891

Tel: 401.596.7747

ISSUED FOR PERMITTING

LEGEND AND GENERAL NOTES

OVERALL SITE PLAN

OWNER/APPLICANT KINGDOM OF THE HAWK, LLC 349 ELM STREET STONINGTON, CT 06378



KINGDOM OF THE HAWK TASTING ROOM 113 PENDLETON HILL ROAD **MAP 122 LOT 2660** NORTH STONINGTON, CONNECTICUT CA JOB # 219099

LEGEND

EXIST	PROP		EXIST	PROP	
27.65 TC 27.15 BC×	27.65 TC 27.15 BC×	TOP/BOTTOM CURB ELEVATION			SUBJECT PROPERTY LINE
21.25×	21.25×	SPOT GRADE			ABUTTERS PROPERTY LINE
⊕ SB−1	⊕ SB-1	SOIL BORING LOCATION	10041119441141144111111111111111		EASEMENT
ф тн-1	⊕ TH-1	TEST HOLE LOCATION	BUILDING SETBACK		BUILDING SETBACK
⊕ MW-1	₩ W-1	MONITORING WELL			CURB
△ BM ∯1	△ BM #1	BENCHMARK			LIMIT OF CURB TYPE
0	⊘ DMH	DRAIN MANHOLE			SAWCUT
□cs	∠ CB	CATCH BASIN		терионионирация	MATCHLINE
DCB	DCB	DOUBLE CATCH BASIN			STOP BAR
FESI⊳	r⊈ FES	FLARED END SECTION	y	, , , , ,	GUARD RAIL
		DRAINAGE LINE		\$199955Y957A	STONE DUST PATH
		UNDERDRAIN PIPE	.~~~	.~~~	TREE LINE
		STONE TRENCH	-x-x-x-	_xx	FENCE
o/h	— 0/н——	OVERHEAD WIRE	1-000000	.0000000	STONE WALL
W	w	WATER LINE	-		RETAINING WALL
	w	FIRE PROTECTION LINE	sī	SF	SILT FENCE
		GAS LINE		sw	STRAW WATTLE
	Ι — Ε —	UNDERGROUND ELECTRIC		LOD	LIMIT OF DISTURBANCE
	t	UNDERGROUND TELEPHONE		•	LOD STAKE
	<u> </u>	FIRE ALARM	2		MINOR CONTOUR
fa	FA	CABLE TV			MAJOR CONTOUR
CQ (V	—— CATV ——	PLUG/STUB	10		BUILDING
	[[SEWER MANHOLE		7	BUILDING DOOR
<u> </u>	⊘ SMH	GRAVITY SEWER LINE	+		
<u>8</u>	5	FORCE MAIN SEWER LINE	0	9	BOLLARD
fm	FM	WATER GATE	D	<u> </u>	DUMPSTER PAD
M	<u> </u>				SIGN
TSV⊳	TSV	TAPPING SLEEVE, VALVE, & BOX	===	==	DOUBLE SIGN
· \$-	•	FIRE HYDRANT		<u> </u>	PARKING COUNT
0	Ø	WELL			CONC. PAVEMENT
0	XX	GAS GATE			PAVEMENT
	Ø	ELECTRIC MANHOLE			PERMEABLE PAVERS
-×-	-	SINGLE LIGHT POLE			GRAVELPAVE/GRASSPAVE
O	0	TELEPHONE MANHOLE		3	ADA PARKING
		UTILITY PAD	— 100° URA —		100 FT UPLAND REVIEW AREA
~	•	UTILITY POLE	△WF #1		WETLAND FLAG
o	•-	GUY POLE			WETLAND EDGE
			秦		WETLAND SYMBOL
		V.			DRAINAGE DIVIDE DURING CONTRUCTION
	<u> </u>		-		ALLOWABLE STAGING/STOCKPILING AREA
	 				FLOW DIRECTION

ABBREVIATIONS

VDDICE	VIAIIONS			
ABAN	ABANDON	MAX	MAXIMUM	
ADJ	ADJUST	MIN	MINIMUM	
ASSF	AREA SUBJECT TO STORM FLOWAGE	мсс	MONOLITHIC CONCRETE CURB	
ASTM	AMERICAN SOCIETY FOR TESTING & MATERIALS	МН	MANHOLE	
ADA	AMERICANS WITH DISABILITIES ACT	NTS	NOT TO SCALE	
APPROX	APPROXIMATE	ос	ON CENTER	
BIT	BITUMINOUS	PVC	POLYVINYLCHLORIDE PIPE	
BCLC/BCC	BITUMINOUS CONCRETE CURB	PCC	PRECAST CONCRETE CURB	
BW	GRADE AT THE BOTTOM OF THE WALL	PL	PROPERTY LINE	
BWL	BROKEN WHITE LINE	PROP	PROPOSED	
BYL	BROKEN YELLOW LINE	R	RADIUS	
ССВ	CAPE COD BERM	RCP	REINFORCED CONCRETE PIPE	
СВ	CATCH BASIN	R&D	REMOVE AND DISPOSE	
CMP	CORRUGATED METAL PIPE	R&R	REMOVE AND RESET	
COL	COLUMN	R&S	REMOVE AND STORE	
CONC	CONCRETE	SMH	SEWER MANHOLE	
CONST	CONSTRUCTION	SESC	SOIL EROSION SEDIMENT CONTROL	
CPP	CORRUGATED PLASTIC PIPE	SWL	SINGLE WHITE LINE	
CY	CUBIC YARD	SWCL	SINGLE WHITE CHANNELIZING LINE	
DBL	DOUBLE	SYL	SINGLE YELLOW LINE	
DCB	DOUBLE CATCH BASIN	SYCL	SINGLE YELLOW CHANNELIZING LINE	
DYL	DOUBLE YELLOW LINE	SF	SQUARE FEET	
DMH	DRAIN MANHOLE	STD	STANDARD	
DI	DUCTILE IRON	SDR	STANDARD DIMENSION RATIO	
DR	DIMENSION RATIO	STA	STATION	
DIPS	DUCTILE IRON PIPE SIZE	ТМН	TELECOMMUNICATION MANHOLE	
ELEV	ELEVATION	TSV	TAPPING SLEEVE, VALVE AND BOX	
EOP	EDGE OF PAVEMENT	TF	TOP OF FRAME	
EXIST	EXISTING	TRANS	TRANSITION	
FT	FEET	TW	ELEVATION OF TOP OF THE WALL	
FES	FLARED END SECTION	TYP	TYPICAL	
HDPE	HIGH DENSITY POLYETHYLENE	UP	UTILITY POLE	
HYD	HYDRANT	VGC	VERTICAL GRANITE CURB	
INV	INVERT ELEVATION	WG	WATER GATE	
LA	LANDSCAPE AREA	WF	WETLAND FLAG	
LOD	LIMIT OF DISTURBANCE			

THESE PLANS AND THEIR CORRESPONDING ELECTRONIC DOCUMENTS INCLUDING CAD FILES FOR THE PROJECT. ARE INSTRUMENTS OF PROFESSIONAL SERVICE AND SHALL NOT BE USED IN WHOLE OR IN PART FOR ANY OTHER PURPOSE THAN THE DEVELOPMENT OF THIS PROJECT WITHOUT THE EXPRESSED. WRITTEN CONSENT OF CHERENZIA & ASSOCIATES, LTD. ANY

UNAUTHORIZED USE, RE-USE, ALTERATION, OR MODIFICATION OF THIS DATA SHALL BE AT THE USER'S RISK WITH NO LIABILITY ON THE PART OF CHERENZIA.

UPON AWARD OF THE CONTRACT AND PRIOR TO THE START OF CONSTRUCTION, THE CONTRACTOR SHALL BE RESPONSIBLE FOR OBTAINING ALL PERMITS AND BONDS AND PAYING ALL STATE AND LOCAL FEES RELATING TO THE WORK SHOWN ON THESE DRAWINGS, THE CONSTRUCTION SPECIFICATIONS, AND CONTRACT DOCUMENTS. THE CONTRACTOR SHALL NOTIFY DIG-SAFE AT LEAST 72 BUSINESS HOURS PRIOR TO INITIATING ANY EXCAVATION WORK. ALL CONSTRUCTION SHALL BE IN ACCORDANCE WITH THE

APPROVED PLANS AND SPECIFICATIONS. WHERE SITE SPECIFICATIONS ARE NOT PROVIDED, THE CONTRACTOR SHALL ADHERE TO LOCAL MUNICIPAL STANDARDS OR THE CONNECTICUT DEPARTMENT OF TRANSPORTATION SPECIFICATIONS, AS APPLICABLE. WORK WITHIN LOCAL RIGHTS-OF-WAY SHALL ADHERE TO LOCAL MUNICIPAL STANDARDS; WORK WITHIN STATE RIGHTS-OF-WAY SHALL ADHERE TO STATE HIGHWAY STANDARDS. WHERE A DISCREPANCY EXISTS, THE MORE RESTRICTIVE

STANDARD SHALL APPLY. REFERENCE MADE TO "STATE HIGHWAY STANDARDS," "STATE STANDARD SPECIFICATIONS," "STANDARD SPECIFICATIONS," OR "CONNOCT STANDARDS" SHALL MEAN AND BE DEFINED AS "CONNECTICUT DEPARTMENT OF TRANSPORTATION STANDARDS AND SPECIFICATIONS'

ANY WORK NOT MEETING THE APPROVED STANDARDS SHALL BE REMOVED IMMEDIATELY AND REPLACED BY THE CONTRACTOR AT NO COST TO THE OWNER.

THE CONTRACTOR SHALL BE RESPONSIBLE FOR ALL SITE SECURITY AND JOB SAFETY AND SHALL CONFORM TO THE RULES AND REGULATIONS OF THE OCCUPATIONAL SAFETY AND HEALTH ADMINISTRATION (OSHA).

THE CONTRACTOR SHALL BE RESPONSIBLE FOR THE MAINTENANCE AND PROTECTION OF PEDESTRIAN AND VEHICULAR TRAFFIC INCLUDING ANY REQUIRED POLICE PROTECTION. ANY REQUIRED TEMPORARY CONSTRUCTION SIGNS, BARRICADES AND LANE. CLOSURES SHALL BE IN CONFORMANCE WITH THE LATEST "MANUAL OF UNIFORM TRAFFIC CONTROL DEVICES" (MUTCD). THE CONTRACTOR SHALL NOT OBSTRUCT PUBLIC ROADWAYS. SIDEWALKS, OR FIRE HYDRANTS WITHOUT FIRST OBTAINING THE NECESSARY PERMITS TO DO SO.

10. ADA ACCESSIBLE ROUTES, PARKING SPACES, SIDEWALKS, AND RAMPS SHALL BE CONSTRUCTED IN ACCORDANCE WITH THE FEDERAL "AMERICANS WITH DISABILITIES ACT (ADA)" AND LOCAL AND STATE STANDARDS. WHERE A DISCREPANCY EXISTS, THE MORE RESTRICTIVE STANDARD SHALL APPLY.

THE LIMITS-OF-WORK (A.K.A. "LIMIT OF DISTURBANCE") SHALL BE AS SHOWN ON THESE PLANS. AREAS DISTURBED BEYOND THESE DEFINED LIMITS SHALL BE RESTORED BY THE CONTRACTOR TO THEIR ORIGINAL CONDITION AT THE CONTRACTOR'S EXPENSE. LANDSCAPE AREAS SHALL BE RESTORED WITH 6 INCHES OF LOAM

SHOULD THE CONTRACTOR ENCOUNTER SUSPECTED CONTAMINATED SOIL, GROUNDWATER, OR OTHER MATERIAL DURING EXCAVATION, THE CONTRACTOR SHALL IMMEDIATELY STOP WORK IN THE SUSPECTED AREA AND NOTIFY THE OWNER SO THAT APPROPRIATE ACTIONS AND TESTING CAN TAKE PLACE. UNLESS OTHERWISE NOTED ON THE PLANS, ALL UNPAVED/ LANDSCAPE AREAS SHALL RECEIVE SIX (6) INCHES OF LOAM AND SEED WITHIN THE LIMITS OF WORK SHOWN ON THESE PLANS. LOAM SHALL BE EVENLY SPREAD, SMOOTHED, AND COMPACTED PRIOR TO SEEDING

PRIOR TO START OF CONSTRUCTION, THE CONTRACTOR SHALL VERIFY EXISTING PAVEMENT ELEVATIONS AT THEIR PROPOSED INTERFACE WITH PROPOSED PAVEMENTS TO ENSURE PROPER TRANSITIONS BETWEEN EXISTING AND PROPOSED FACILITIES HORIZONTAL AND VERTICAL DATUMS ARE PROVIDED ON THE

SURVEY PLANS.

1. THE CONTRACTOR SHALL BE RESPONSIBLE FOR COORDINATING WITH ALL UTILITY COMPANIES AND WORK TRADES ASSOCIATED WITH THE WORK SHOWN ON THESE PLANS.

PRIVATE UTILITIES a. SERVICES SHALL BE APPROVED BY AND CONSTRUCTED IN ACCORDANCE WITH THE SPECIFICATIONS AND REQUIREMENTS OF PRIVATE UTILITY SERVICE PROVIDERS (WATER, SEWER, GAS, TELEPHONE, ELECTRIC, FIRE ALARM, CABLE, FIOS, ETC.)

b. THE GAS COMPANY SHALL INSTALL ALL GAS LINES AND APPURTENANCES; THE CONTRACTOR SHALL ONLY BE RESPONSIBLE FOR EXCAVATION AND BACKFILL OF GAS TRENCHES IN ACCORDANCE WITH GAS COMPANY REQUIREMENTS.

c. CONTRACTOR SHALL FURNISH EXCAVATION, INSTALLATION, AND BACKFILL OF ALL ELECTRIC WORK. THE CONTRACTOR SHALL ALSO FURNISH AND INSTALL CONCRETE ENCASEMENT FOR DUCT BANKS, IF REQUIRED BY THE ELECTRIC COMPANY. PULLING OF ELECTRICAL CONDUIT SHALL BE BY THE ELECTRIC COMPANY.

EXISTING UTILITIES ARE SHOWN IN THEIR APPROXIMATE LOCATION BASED ON BEST AVAILABLE INFORMATION. THE CONTRACTOR SHALL BE RESPONSIBLE TO VERIFY THE LOCATION, SIZE, MATERIAL(S), AND ELEVATION OF ALL EXISTING UTILITIES WITHIN THE LIMIT OF WORK PRIOR TO ORDERING OR INSTALLING THESE MATERIALS. THE CONTRACTOR SHALL NOTIFY THE ENGINEER IMMEDIATELY OF ANY DISCREPANCIES OR UTILITY CONFLICTS PRIOR TO CONSTRUCTION.

WHERE AN EXISTING UTILITY IS FOUND TO BE IN CONFLICT WITH THE PROPOSED WORK, OR WHERE EXISTING CONDITIONS DIFFER FROM THE INFORMATION SHOWN ON THESE PLANS. SUCH THAT THE WORK CAN NOT BE COMPLETED AS INTENDED. THE CONTRACTOR SHALL IMMEDIATELY IDENTIFY AND PROVIDE THE ENGINEER WITH THE LOCATION, ELEVATION, AND SIZE OF THE UTILITY IN CONFLICT. THE CONTRACTOR SHALL NOT CONTINUE WORK IN THIS AREA UNTIL THE APPROPRIATE REMEDIAL ACTION IS AGREED UPON BY

THE OWNER AND ENGINEER. THE CONTRACTOR SHALL ASSUME RESPONSIBILITY FOR ANY DAMAGE TO OVERHEAD AND/OR UNDERGROUND UTILITIES. WHETHER OR NOT SHOWN ON THESE PLANS THROUGHOUT WORK ON THIS PROJECT.

UTILITY PIPING SHALL BE CONSTRUCTED OF THE FOLLOWING MATERIALS, UNLESS OTHERWISE NOTED ON THE PLANS: a. SANITARY SEWER PIPES SHALL BE SDR35 POLYVINYL CHLORIDE

b. STORM DRAINAGE PIPES SHALL BE HIGH-DENSITY POLYETHYLENE (HDPE) ALL DRAINAGE AND SANITARY SEWER MANHOLE DIAMETERS SHALL BE A MINIMUM OF FOUR (4) FEET AND AS DETERMINED BY

THE MANHOLE MANUFACTURER(S), BASED ON THE PIPE CONFIGURATIONS SHOWN ON THESE PLANS AND LOCAL MUNICIPAL STANDARDS.

9. ALL STRUCTURES UNDER PAVED AREAS SHALL BE DESIGNED TO MEET HS-20 TRUCK LOAD.

LAYOUT AND MATERIALS NOTES

THE CONTRACTOR SHALL NOT RELY SOLELY ON ELECTRONIC VERSIONS OF PLANS, SPECIFICATIONS, AND DATA FILES THAT ARE OBTAINED FROM THE DESIGNERS, BUT SHALL VERIFY LOCATION OF PROJECT FEATURES IN ACCORDANCE WITH PAPER COPIES OF THE PLANS AND SPECIFICATIONS THAT ARE SUPPLIED AS PART OF THE CONTRACT DOCUMENTS.

SYMBOLS AND LEGENDS OF PROJECT FEATURES ARE GRAPHIC REPRESENTATIONS AND ARE NOT NECESSARILY SCALED TO THE ACTUAL DIMENSIONS OR LOCATIONS ON THE DRAWINGS. THE CONTRACTOR SHALL REFER TO THE DETAIL SHEET DIMENSIONS. MANUFACTURERS' LITERATURE, SHOP DRAWINGS AND FIELD MEASUREMENTS OF SUPPLIED PRODUCTS FOR LAYOUT OF THE

DIMENSIONS ARE TO/FROM FACE OF CURB, FACE OF BUILDING, FACE OF WALL, AND CENTER LINE OF PAVEMENT MARKINGS, UNLESS OTHERWISE NOTED ON THESE PLANS.

PROJECT FEATURES

4. PROPOSED BOUNDS AND ANY OTHER EXISTING PROPERTY LINE MONUMENTATION DISTURBED DURING CONSTRUCTION SHALL BE SET OR RESET BY A PROFESSIONAL LICENSED SURVEYOR. THE CONTRACTOR SHALL PROVIDE TEMPORARY BITUMINOUS

PATCH FOR ANY TRENCH WORK WITHIN PAVEMENT OR SIDEWALK AREAS IN PUBLIC RIGHTS-OF-WAY UNTIL PERMANENT PATCHING IS 6. CURBING SHALL BE BITUMINOUS CONCRETE CURB (BCC) WITH A

3-FOOT RADIUS (3'R), UNLESS OTHERWISE NOTED ON THE PLANS.

WITHIN THE LIMIT OF WORK/DISTURBANCE, THE CONTRACTOR SHALL CLEAR AND GRUB ALL EXISTING VEGETATION AND STOCKPILE AND SCREEN TOPSOIL FOR RE-USE IN LANDSCAPE AREAS, THE CONTRACTOR SHALL ALSO REMOVE AND DISPOSE OF

ALL EXISTING MANMADE FEATURES, INCLUDING BUT NOT LIMITED TO BUILDINGS, STRUCTURES, PAVEMENTS, SLABS, CURBING WALLS, FENCES, UTILITIES (BOTH OVERHEAD AND UNDERGROUND), SIGNS, ETC., EXCEPT AS OTHERWISE NOTED ON THESE PLANS. WITHIN THE PROPOSED BUILDING ENVELOPE AND TO A DISTANCE OF 10 FEET AROUND THE BUILDING PERIMETER, THE CONTRACTOR

SHALL FURNISH AND INSTALL GRAVEL FILL TO THE PROPOSED BUILDING SUBGRADE THE CONTRACTOR SHALL DISPOSE OF ALL MATERIALS OFF-SITE IN ACCORDANCE WITH FEDERAL, STATE, AND LOCAL REGULATIONS. THE EXTENT OF DEMOLITION DEPICTED ON THESE PLANS IS

SHALL REMOVE AND DISPOSE OF ALL UNSUITABLE MATERIALS AND

INTENDED TO AID THE CONTRACTOR IN BIDDING THE PROJECT AND IS NOT NECESSARILY INTENDED TO DEPICT EACH AND EVERY ELEMENT OF DEMOLITION. THE CONTRACTOR SHALL BE RESPONSIBLE FOR DETERMINING THE FULL EXTENTS OF THE DEMOLITION WORK PRIOR TO CONTRACT AWARD AND SHALL NOT BE COMPENSATED FOR UNFORESEEN CONDITIONS ONCE THE WORK HAS COMMENCED.

EXISTING UTILITIES SHALL BE TERMINATED IN CONFORMANCE WITH APPLICABLE FEDERAL, STATE, LOCAL, AND SERVICE PROVIDER REQUIREMENTS.

UNLESS OTHERWISE SPECIFICALLY PROVIDED ON THESE PLANS, THE ENGINEER HAS NOT PREPARED PLANS FOR THE DISCOVERY, REMOVAL, ABATEMENT, OR DISPOSAL OF ANY HAZARDOUS OR TOXIC MATERIALS FOUND DURING CONSTRUCTION

EROSION CONTROLS/CONSTRUCTION SEQUENCING

 PRIOR TO THE START OF CONSTRUCTION OF ANY EARTHWORK ACTIVITIES. THE CONTRACTOR SHALL NOTIFY ALL APPLICABLE AGENCIES AND INSTALL THE EROSION CONTROL MEASURES SHOWN ON THESE PLANS IN ACCORDANCE WITH ALL FEDERAL, STATE, AND LOCAL PERMITS PERTAINING TO THIS PROJECT.

2. THE CONTRACTOR SHALL KEEP A COPY OF THE "SOIL EROSION AND SEDIMENTATION CONTROL PLAN" (SESC) AND THE APPROVED PLAN SET AT THE CONSTRUCTION SITE AT ALL TIMES. 3. THE CONTRACTOR SHALL INSTALL ALL EROSION AND

SEDIMENTATION (E&S) CONTROL MEASURES SHOWN ON THE PLAN SET IN ACCORDANCE WITH THE MOST RECENT EDITION OF THE "CONNECTICUT GUIDELINES FOR SOIL EROSION AND SEDIMENT

4. THE CONTRACTOR SHALL BE RESPONSIBLE TO MAINTAIN AND/OR UPGRADE THESE MEASURES, AS NECESSARY, THROUGHOUT CONSTRUCTION, TO MEET THE REQUIREMENTS OF ALL RELATED PERMITS FOR THE PROJECT.

5. THE CONTRACTOR SHALL PREPARE AND MAINTAIN A RED-LINED COPY OF THE SESC PLAN SHOWING INTENDED AREAS FOR STAGING. STOCKPILING, WASHOUT, SOLID WASTE CONTAINMENT CONSTRUCTION ENTRANCE/EXIT AND TEMPORARY SEDIMENTATION CONTROL AREAS. ALL SUCH AREAS SHALL BE LOCATED OUTSIDE OF REGULATED WETLAND AREAS OR AREAS INTENDED FOR INFILTRATION PRACTICES.

6. EROSION CONTROL DEVICES a. AT LEAST ONE STABILIZED CONSTRUCTION ENTRANCE/EXIT SHALL BE INSTALLED FOR ACCESS TO THE PROJECT BY CONSTRUCTION VEHICLES. THE CONSTRUCTION ENTRANCE SHALL BE INSTALLED BEFORE CONSTRUCTION VEHICLES WILL BE ALLOWED TO ENTER THE CONSTRUCTION SITE. ADDITIONAL ENTRANCES/EXITS SHALL BE INSTALLED, IF MORE THAN ONE ACCESS POINT IS ANTICIPATED BY THE CONTRACTOR. A WASH OUT PAD MAY ALSO BE INSTALLED TO WASH CONSTRUCTION

VEHICLES EXITING THE SITE. b. ROADS ADJACENT TO THE CONSTRUCTION SITE SHALL BE CLEAN AT THE END OF EACH WORK DAY.

c. TEMPORARY SEDIMENT TRAPS MAY BE EXCAVATED OR BERMED/HAYBALED AND SHALL BE SIZED IN ACCORDANCE WITH THE "CONNECTICUT GUIDELINES FOR SOIL EROSION AND SEDIMENT CONTROL" DISCHARGE LOCATION FROM THESE BASINS SHALL BE STABILIZED TO PREVENT EROSION.

d. STRAW WATTLE AND/OR SILT SACKS SHALL BE INSTALLED AT ALL DOWN-GRADIENT CATCH BASINS WITHIN THE LIMIT OF WORK TO CONTROL EROSION AND SEDIMENTATION AND TO PROTECT OFF-SITE AREAS. THESE DEVICES SHALL BE INSTALLED AS SHOWN ON THE SOIL EROSION SEDIMENT CONTROL PLAN PRIOR TO INITIATION OF MAJOR SITE WORK ACTIVITIES AND SHALL BE MAINTAINED/REPAIRED UNTIL FINAL STABILIZATION OF ALL DISTURBED AREAS.

e. SILT FENCE SHALL BE INSTALLED AROUND ALL EARTH

f. ALL OTHER EROSION CONTROL DEVICES SHOWN ON THESE PLANS SHALL BE IN ACCORDANCE WITH THE "CONNECTICUT GUIDELINES FOR SOIL EROSION AND SEDIMENTATION CONTROL."

7. THE EROSION CONTROL MEASURES SHOWN ON THESE PLANS ARE INTENDED TO BE THE MINIMUM NECESSARY AT THE START OF CONSTRUCTION. THE CONTRACTOR SHALL BE RESPONSIBLE TO MAINTAIN AND SUPPLEMENT THESE EROSION CONTROLS, AS NECESSARY THROUGHOUT CONSTRUCTION, TO PREVENT DAMAGE TO WETLANDS AND/OR SURROUNDING PROPERTIES.

8. THE CONTRACTOR SHALL PREVENT DUST, DEBRIS, OR SEDIMENTS FROM LEAVING THE SITE DURING CONSTRUCTION AND SHALL BE RESPONSIBLE TO REPAIR, CLEAN UP, OR TAKE OTHER CORRECTIVE ACTION IMMEDIATELY OR NO LATER THAN 24 HOURS AFTER ANY ISSUE ARISES.

9. THE CONTRACTOR SHALL CONTROL CONSTRUCTION STORMWATER RUNOFF IN SUCH A MANNER AS TO PREVENT DAMAGE TO DOWN-GRADIENT PROPERTIES; ANY PROPERTIES SO DAMAGED SHALL BE REPAIRED AT THE CONTRACTOR'S EXPENSE

10. THE CONTRACTOR SHALL INSPECT ALL EROSION CONTROL DEVICES ON A WEEKLY BASIS AND WITHIN 12 HOURS AFTER A RAINFALL EVENT. THE CONTRACTOR SHALL IMMEDIATELY REPAIR DAMAGED DEVICES AND SHALL REMOVE ACCUMULATED SEDIMENTS IN ACCORDANCE WITH LOCAL REQUIREMENTS AND PERMITS, WHEN APPLICABLE. ACCUMULATED SEDIMENTS SHALL BE REMOVED FROM THE SITE OR PLACED AWAY FROM WETLANDS AND CLOSED

11. THE CONTRACTOR SHALL MAKE EVERY EFFORT TO PERFORM EARTHWORK IN PHASES THAT ALLOW FOR STABILIZATION OF THESE AREAS IN A RELATIVELY SHORT TIME PERIOD AND TO DISCOURAGE EROSION AND SEDIMENTATION. ANY EXPOSED SOILS INTENDED TO REMAIN FOR MORE THAN 14 DAYS SHALL BE STABILIZED WITH MULCH, OR TEMPORARY SEED AND WATERED TO ENCOURAGE VEGETATION.

12. THE CONTRACTOR SHALL INSTALL PERMANENT SEEDING BETWEEN APRIL 15TH AND JUNE 15TH AND/OR AUGUST 15TH TO OCTOBER 15TH. 13. THE CONTRACTOR SHALL APPLY PERMANENT SOIL STABILIZATION MEASURES TO ALL GRADED AREAS WITHIN SEVEN (7) DAYS OF

ESTABLISHING FINAL GRADE. 14. THE CONTRACTOR SHALL PERFORM A FINAL INSPECTION OF ALL EXISTING CATCH BASINS, DRAINAGE PIPING, AND ASSOCIATED DRAINAGE STRUCTURES WITHIN THE PROJECT LIMITS TO ENSURE THAT ALL SEDIMENTS HAVE BEEN REMOVED BEFORE WORK IS DEEMED COMPLETE.

15. THE CONTRACTOR SHALL REMOVE AND DISPOSE OF ALL SESC MEASURES ONLY AFTER FINAL PAVEMENT IS PLACED AND VEGETATION IN LANDSCAPE AREAS IS WELL ESTABLISHED.

INFILTRATION AREAS

TO ENSURE THE LONG-TERM FUNCTION AND VALUE OF ANY AREA PROPOSED FOR INFILTRATION, INCLUDING BUT NOT LIMITED TO BIORETENTION BASINS, SAND FILTERS, SURFACE INFILTRATION BASINS, AND SUBSURFACE INFILTRATION CHAMBERS, THE CONTRACTOR SHALL EXERCISE THE FOLLOWING BEST MANAGEMENT PRACTICES THROUGHOUT CONSTRUCTION:

1. THESE AREAS SHALL NOT BE USED FOR TEMPORARY CONSTRUCTION SEDIMENTATION CONTROL, TEMPORARY SEDIMENTATION TRAPS, OR DEWATERING AREAS.

2. THESE AREAS SHALL REMAIN OFF-LINE UNTIL THE ENTIRE CONSTRUCTION AREA CONTRIBUTING TO THESE AREAS HAS BEEN STABILIZED WITH BUILDINGS, BUILDING FOUNDATIONS, PAVEMENT, OR VEGETATION, AS APPLICABLE.

3. STORMWATER RUNOFF DURING CONSTRUCTION SHALL BE DIRECTED AWAY FROM THESE AREAS TO THE GREATEST EXTENT PRATICABLE. WHERE NOT FEASIBLE, THE CONTRACTOR SHALL INSTALL ADDITIONAL EROSION CONTROLS UP-GRADIENT OF THESE AREAS TO PREVENT SEDIMENTATION OF THESE AREAS DURING CONSTRUCTION. 4. THE SUBGRADE BELOW THESE AREAS SHALL NOT BE COMPACTED; THEREFORE, THE CONTRACTOR SHALL RESTRICT ACCESS TO THESE

FOR MATERIALS STOCKPILES. 5. EXCAVATION AND CONSTRUCTION OF THESE AREAS SHALL BE PERFORMED USING HAND OR HYDRAULIC EQUIPMENT TO ENSURE THAT THE NATURAL FILTRATION EARTH MATERIAL IS NOT DISTURBED OR OTHERWISE COMPACTED

AREAS BY HEAVY EQUIPMENT AND SHALL NOT USE THESE AREAS

6. UPON COMPLETION OF CONSTRUCTION OF ANY OF THESE AREAS, THE CONTRACTOR SHALL INSTALL EROSION CONTROL MEASURES TO PREVENT SILTATION OF THE FILTER MATERIALS.

Pawcatuck, CT 06379 Westerly, RJ 02891 Tel: 860.629.6500 Tel: 401.596.7747 Land Surveyors Fax: 860.599.6090 Land Use Planners

Environmental Engineers www.cherenzia.com

DI AN DEVISIONS

	PLAN REVISIONS				
REV. NO.	DATE	DESCRIPTION	DWN C BY F		
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ISSUED FOR PERMITTING

CHECK BY: SFC

LEGEND & GENERAL NOTES


KINGDOM OF THE HAWK TASTING ROOM 113 PENDLETON HILL ROAD MAP 122 LOT 2660 NORTH STONINGTON, CONNECTICUT


PREPARED FOR KINGDOM OF THE HAWK, LLC.




CA JOB #219099

MAY 4, 2021

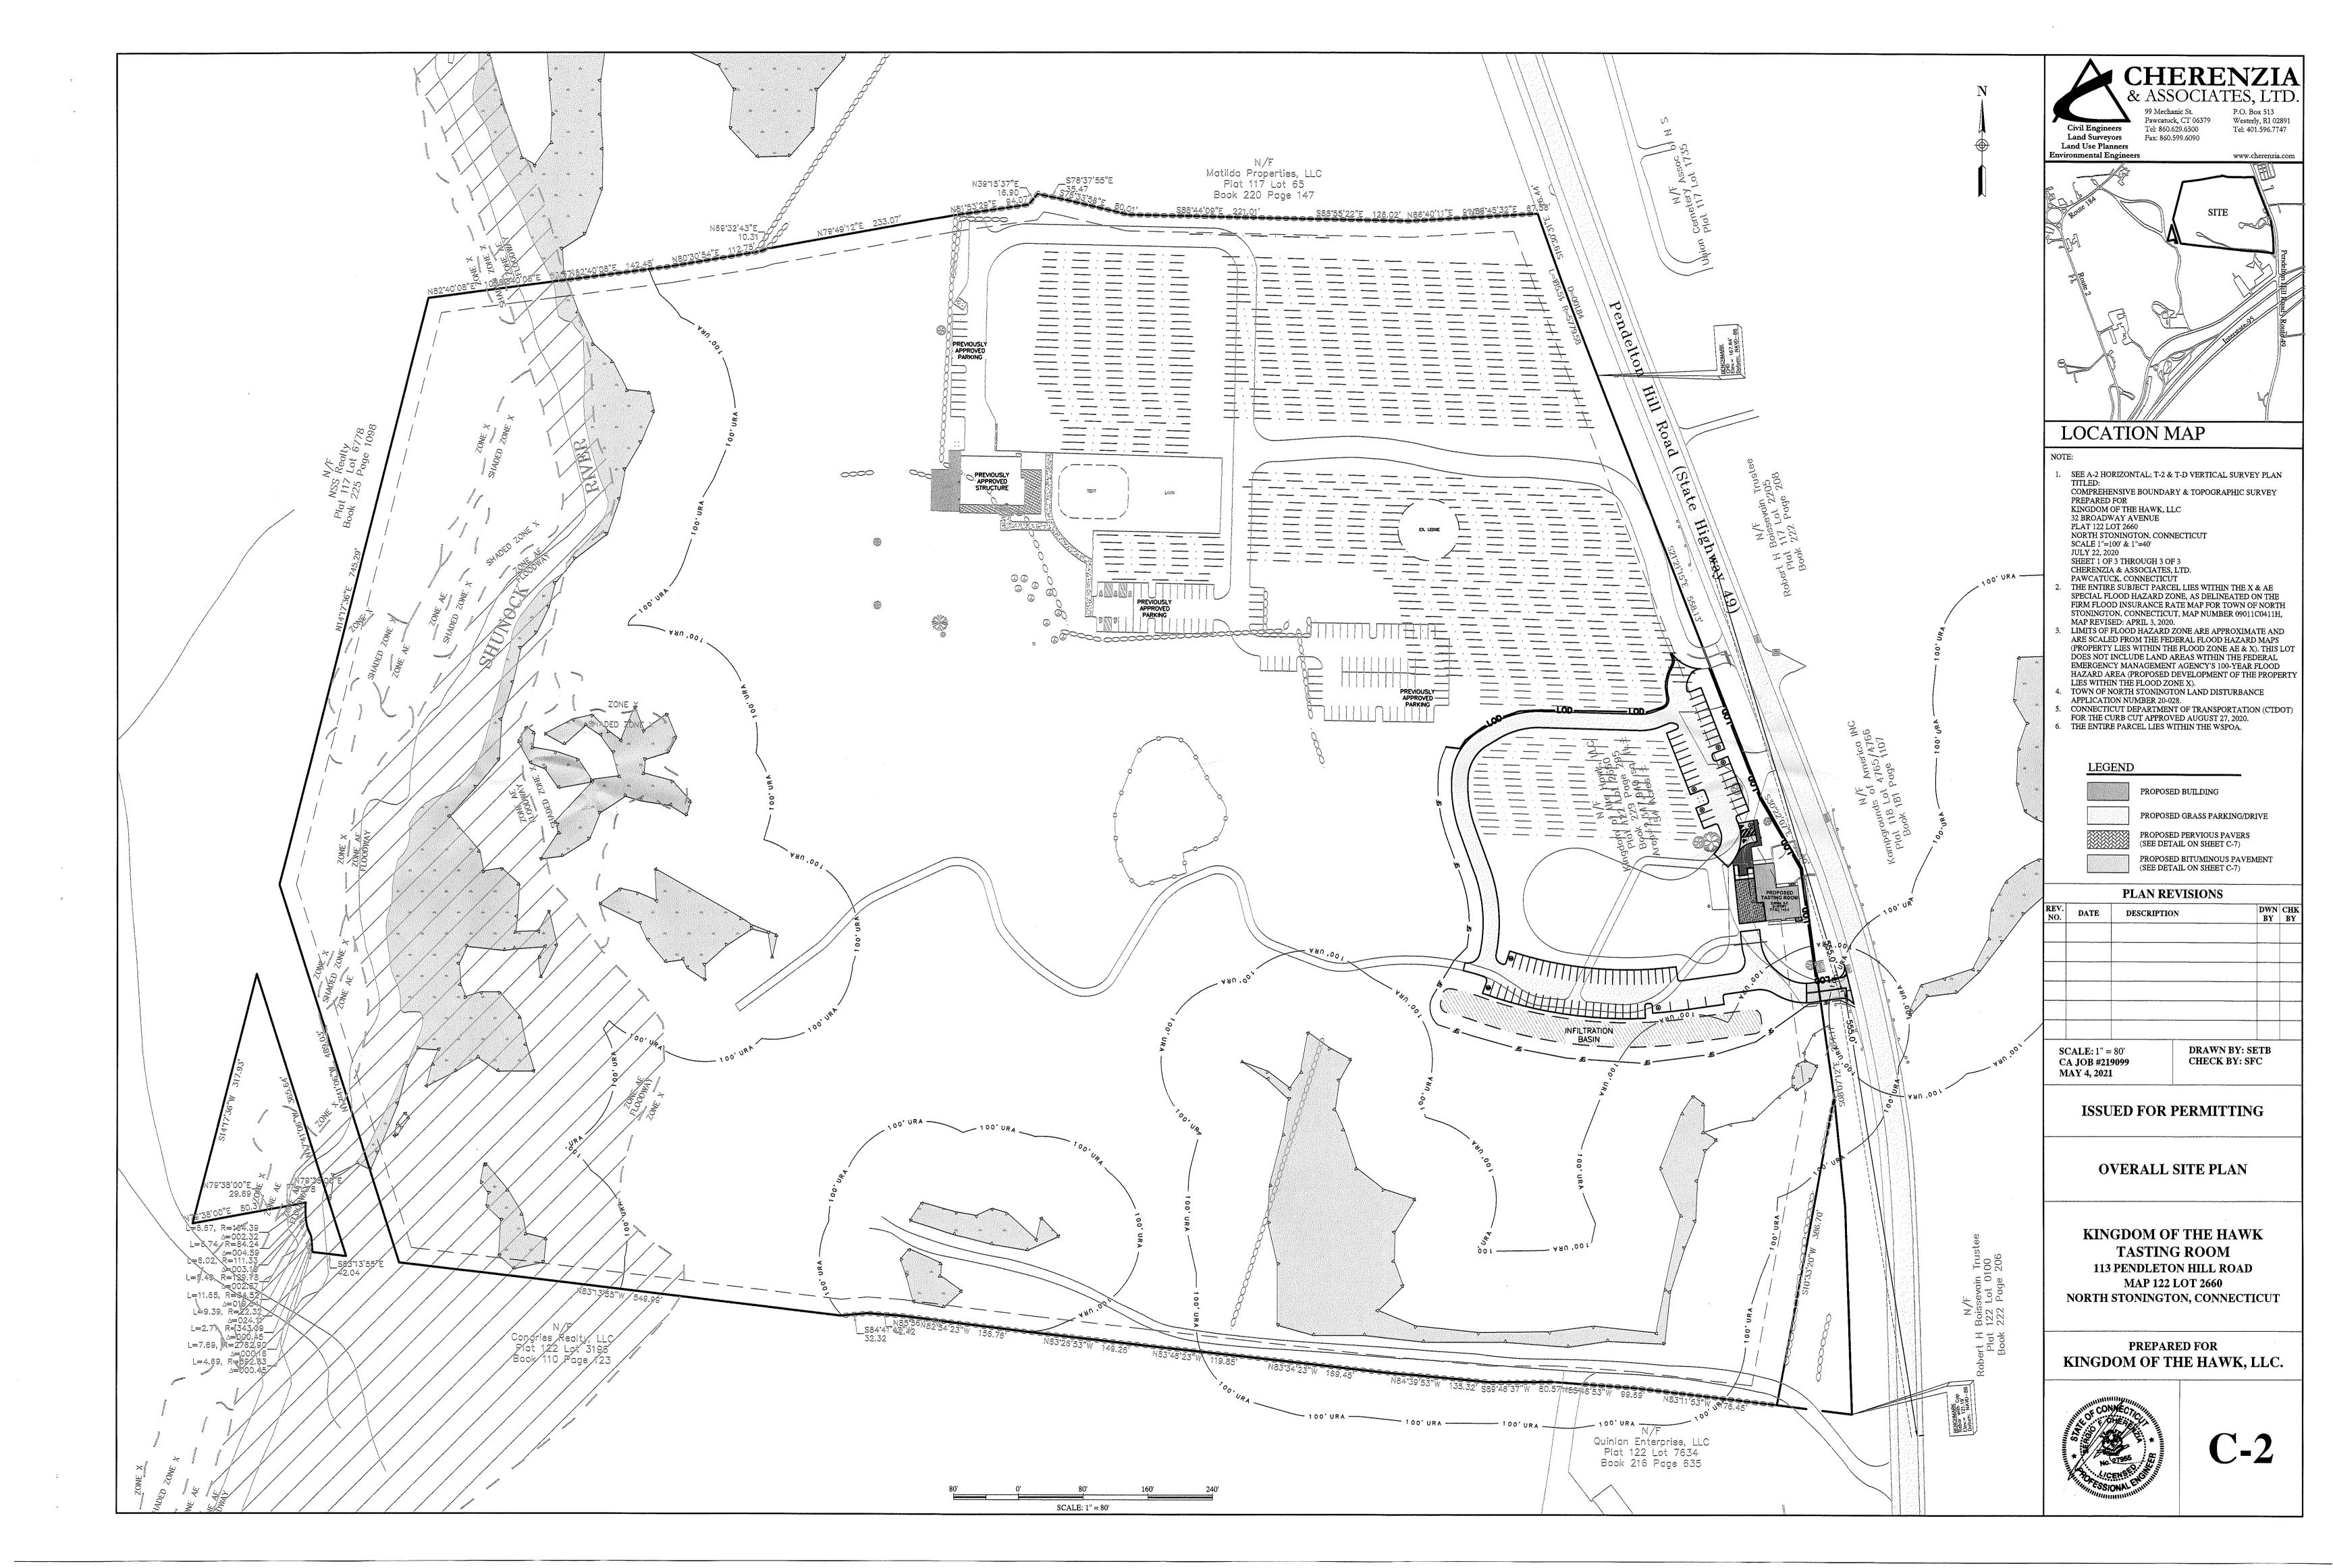

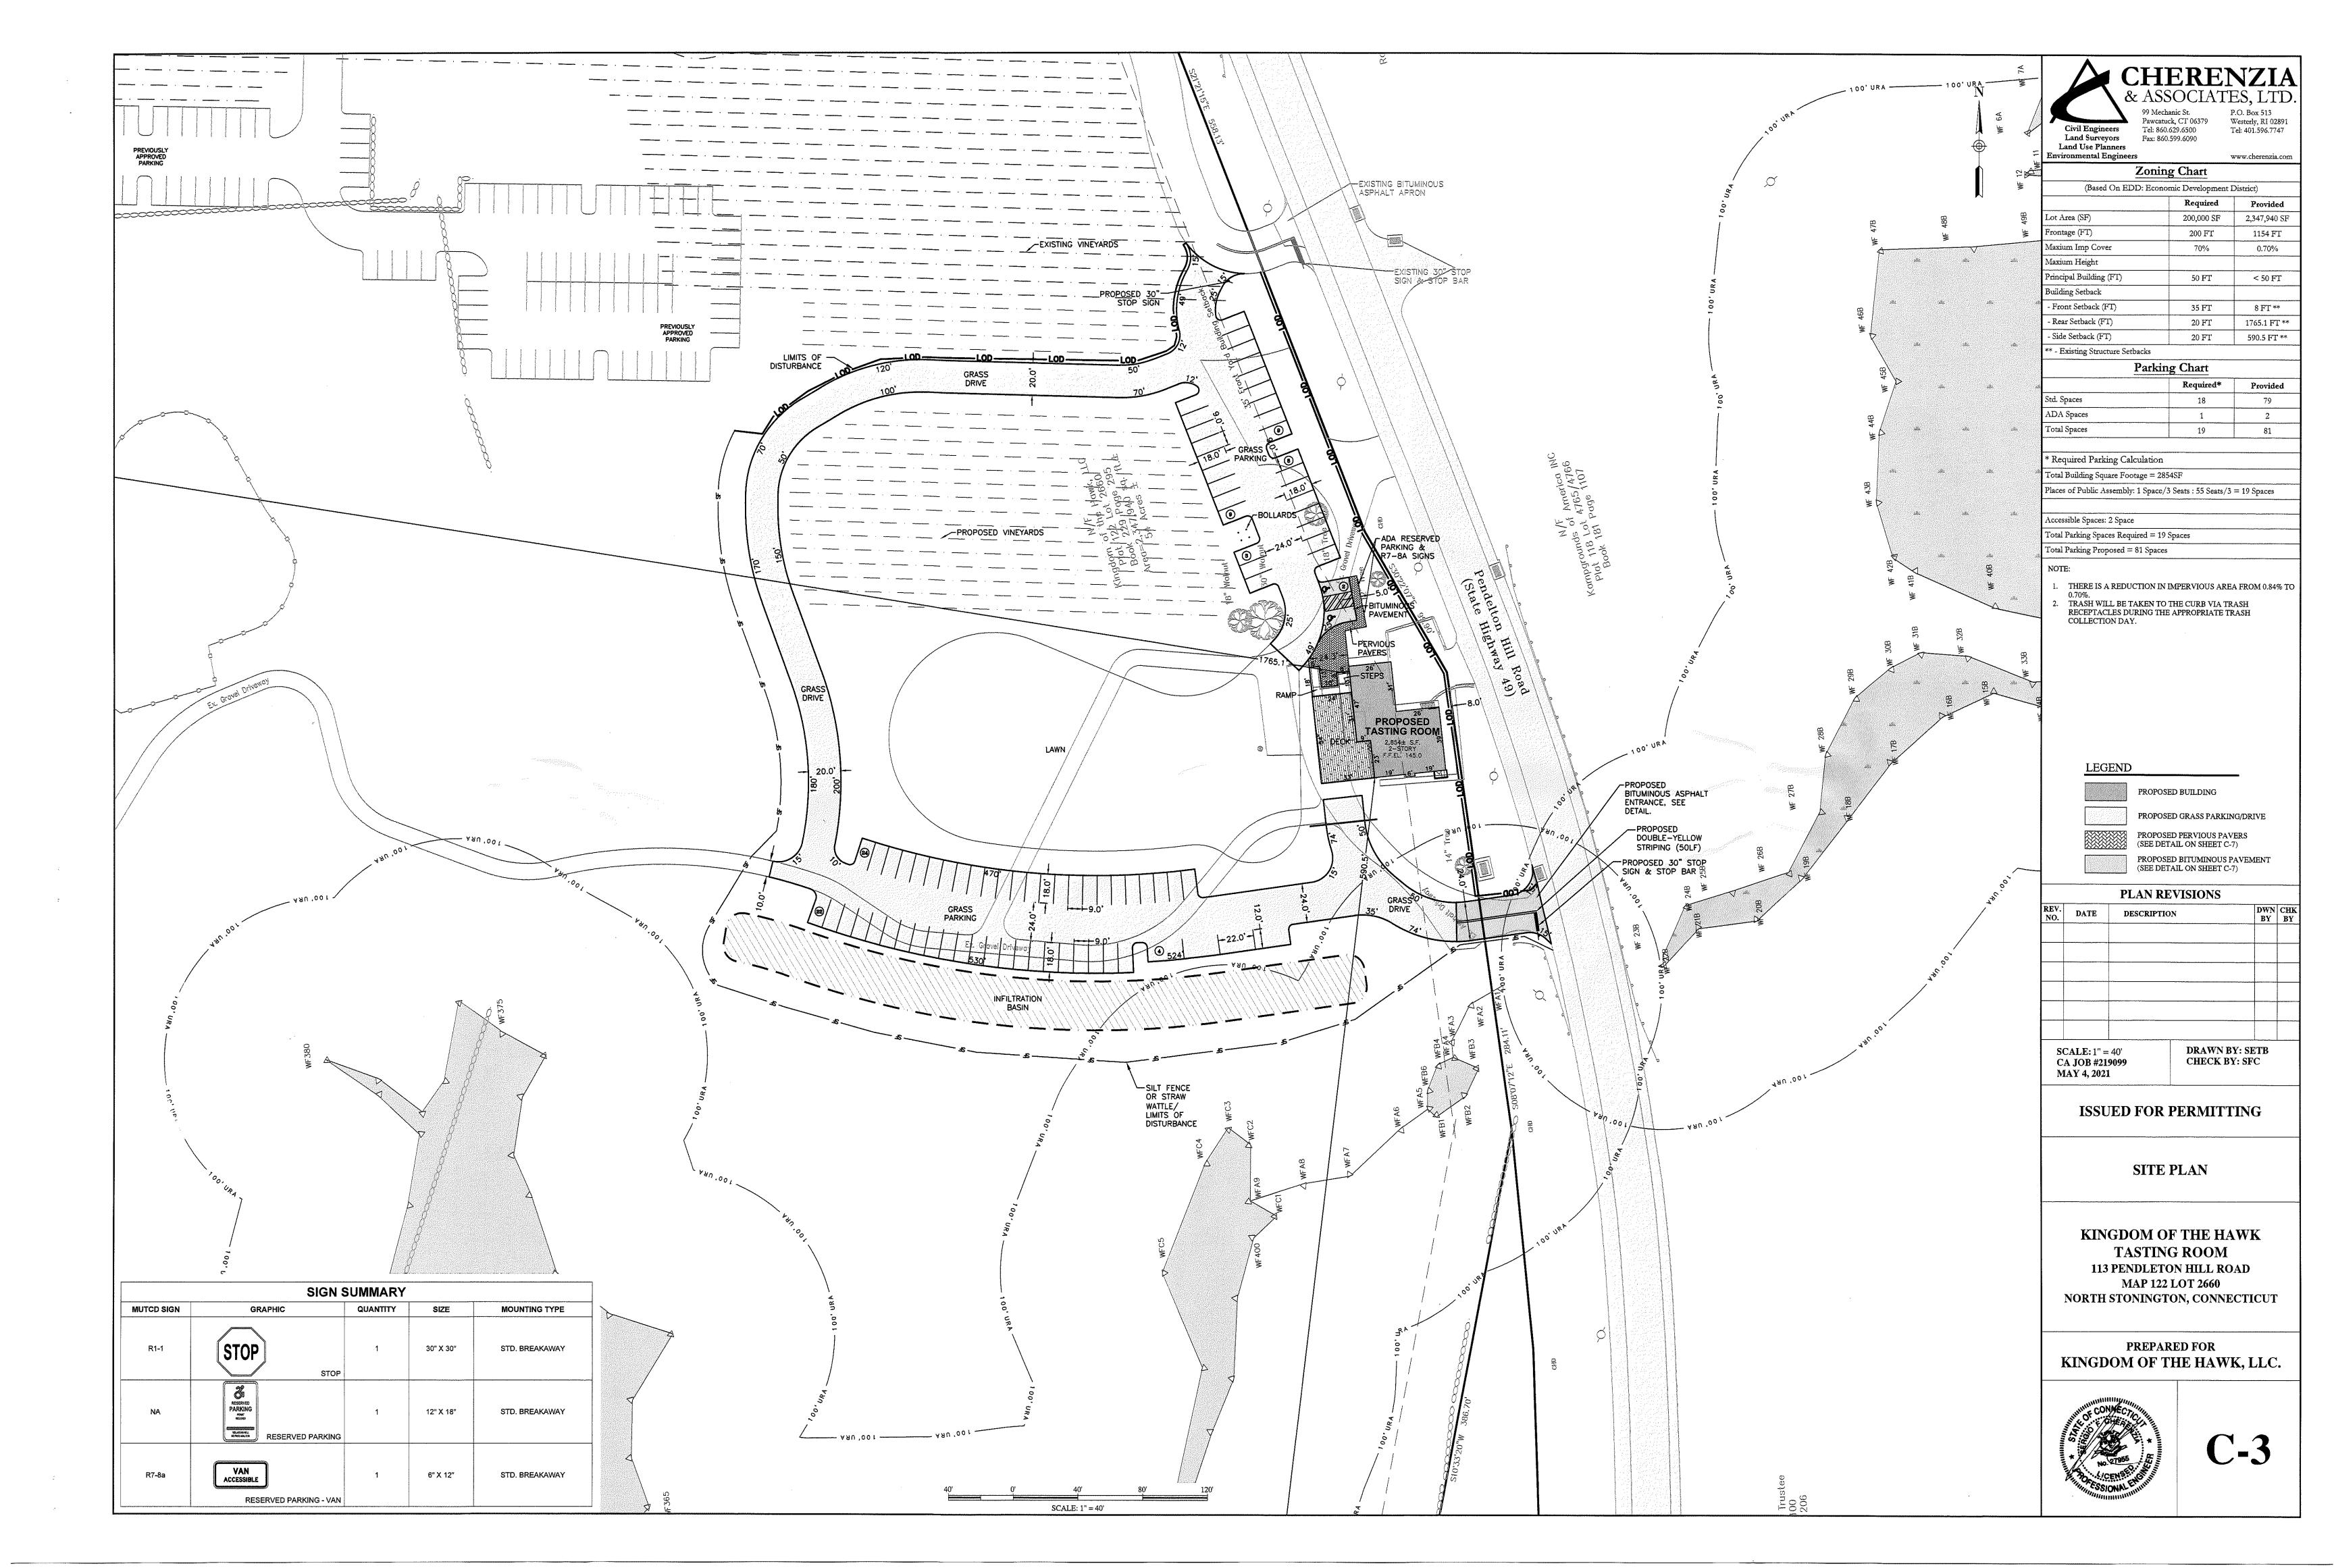

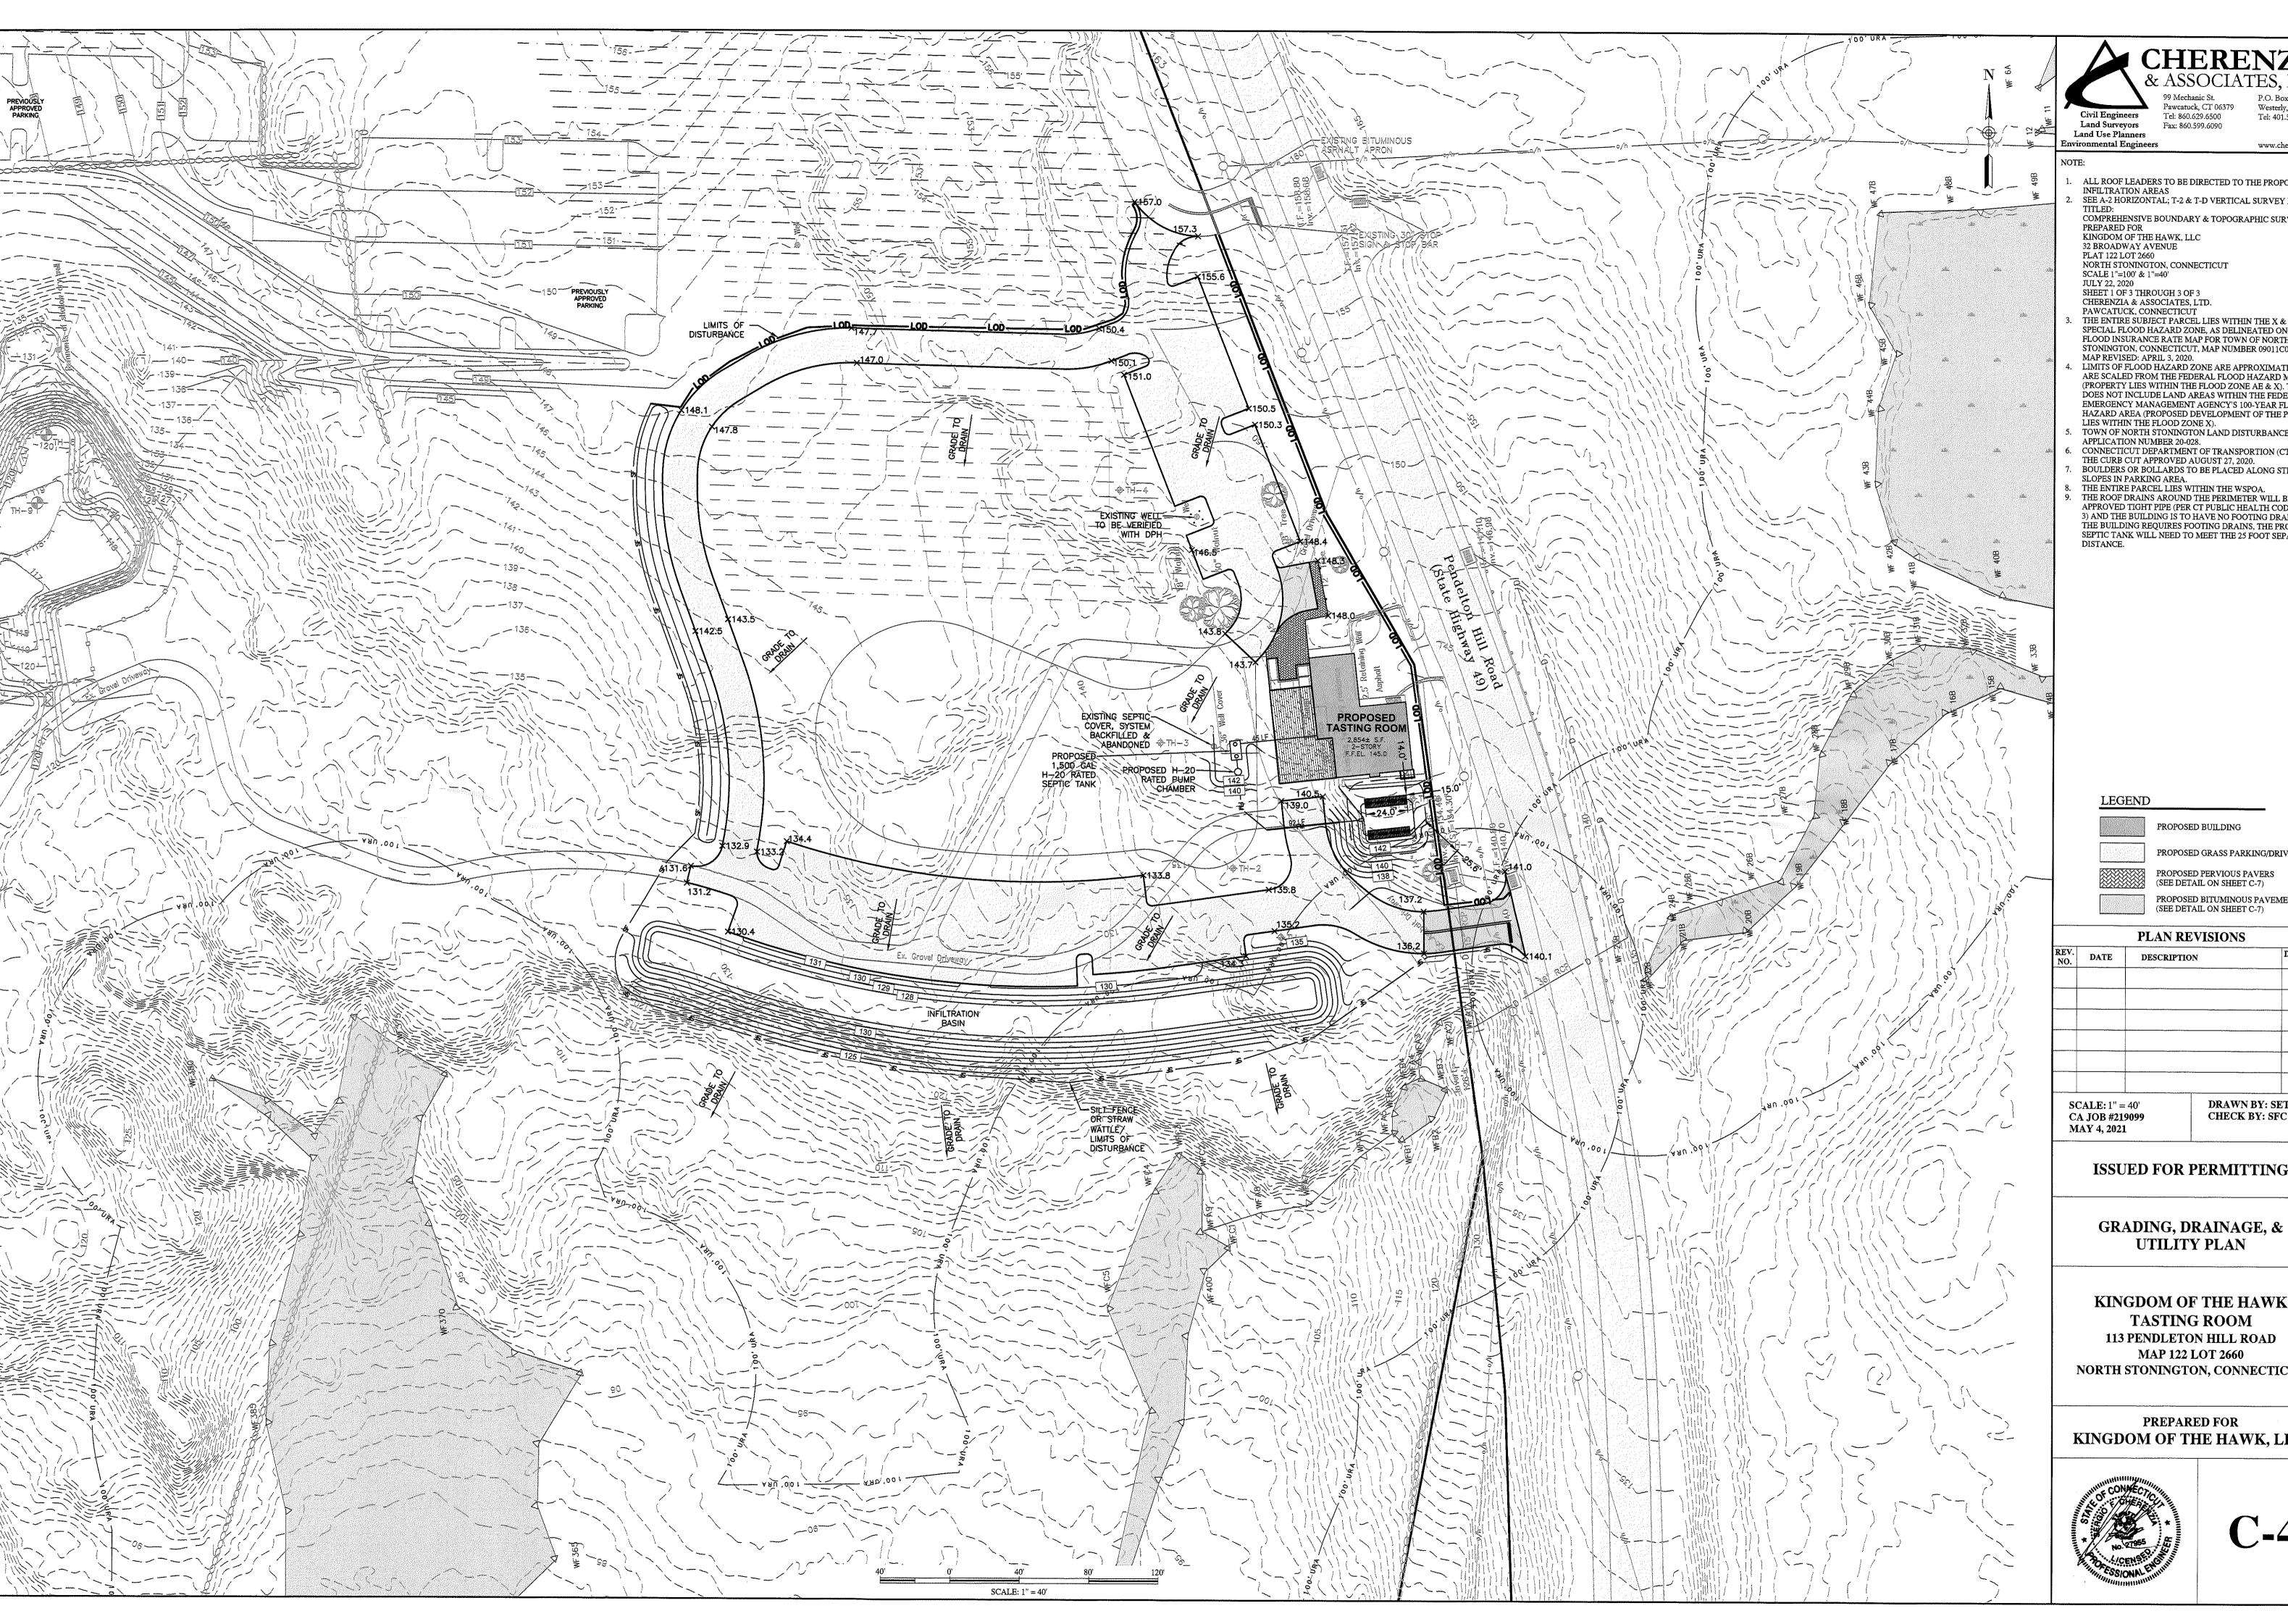

99 Mechanic St. P.O. Box Pawcatuck, CT 06379 Westerly, Tel: 860.629.6500 Tel: 401.5 Fax: 860.599.6090

ALL ROOF LEADERS TO BE DIRECTED TO THE PROPOSINFILTRATION AREAS

TITLED:
COMPREHENSIVE BOUNDARY & TOPOGRAPHIC SUR'
PREPARED FOR
KINGDOM OF THE HAWK, LLC
32 BROADWAY AVENUE
PLAT 122 LOT 2660
NORTH STONINGTON, CONNECTICUT
SCALE 1"=100' & 1"=40'
JULY 22, 2020
SHEET 1 OF 3 THROUGH 3 OF 3

MAP REVISED: APRIL 3, 2020. LIMITS OF FLOOD HAZARD ZONE ARE APPROXIMA'

APPLICATION NUMBER 20-028.
CONNECTICUT DEPARTMENT OF TRANSPORTION (CT

SLOPES IN PARKING AREA. 3) AND THE BUILDING IS TO HAVE NO FOOTING DRAITHE BUILDING REQUIRES FOOTING DRAINS, THE PRO

PROPOSED BUILDING

PROPOSED GRASS PARKING/DRIV PROPOSED PERVIOUS PAVERS (SEE DETAIL ON SHEET C-7)

PROPOSED BITUMINOUS PAVEME (SEE DETAIL ON SHEET C-7)

PLAN REVISIONS

DESCRIPTION

DRAWN BY: SET CHECK BY: SFC


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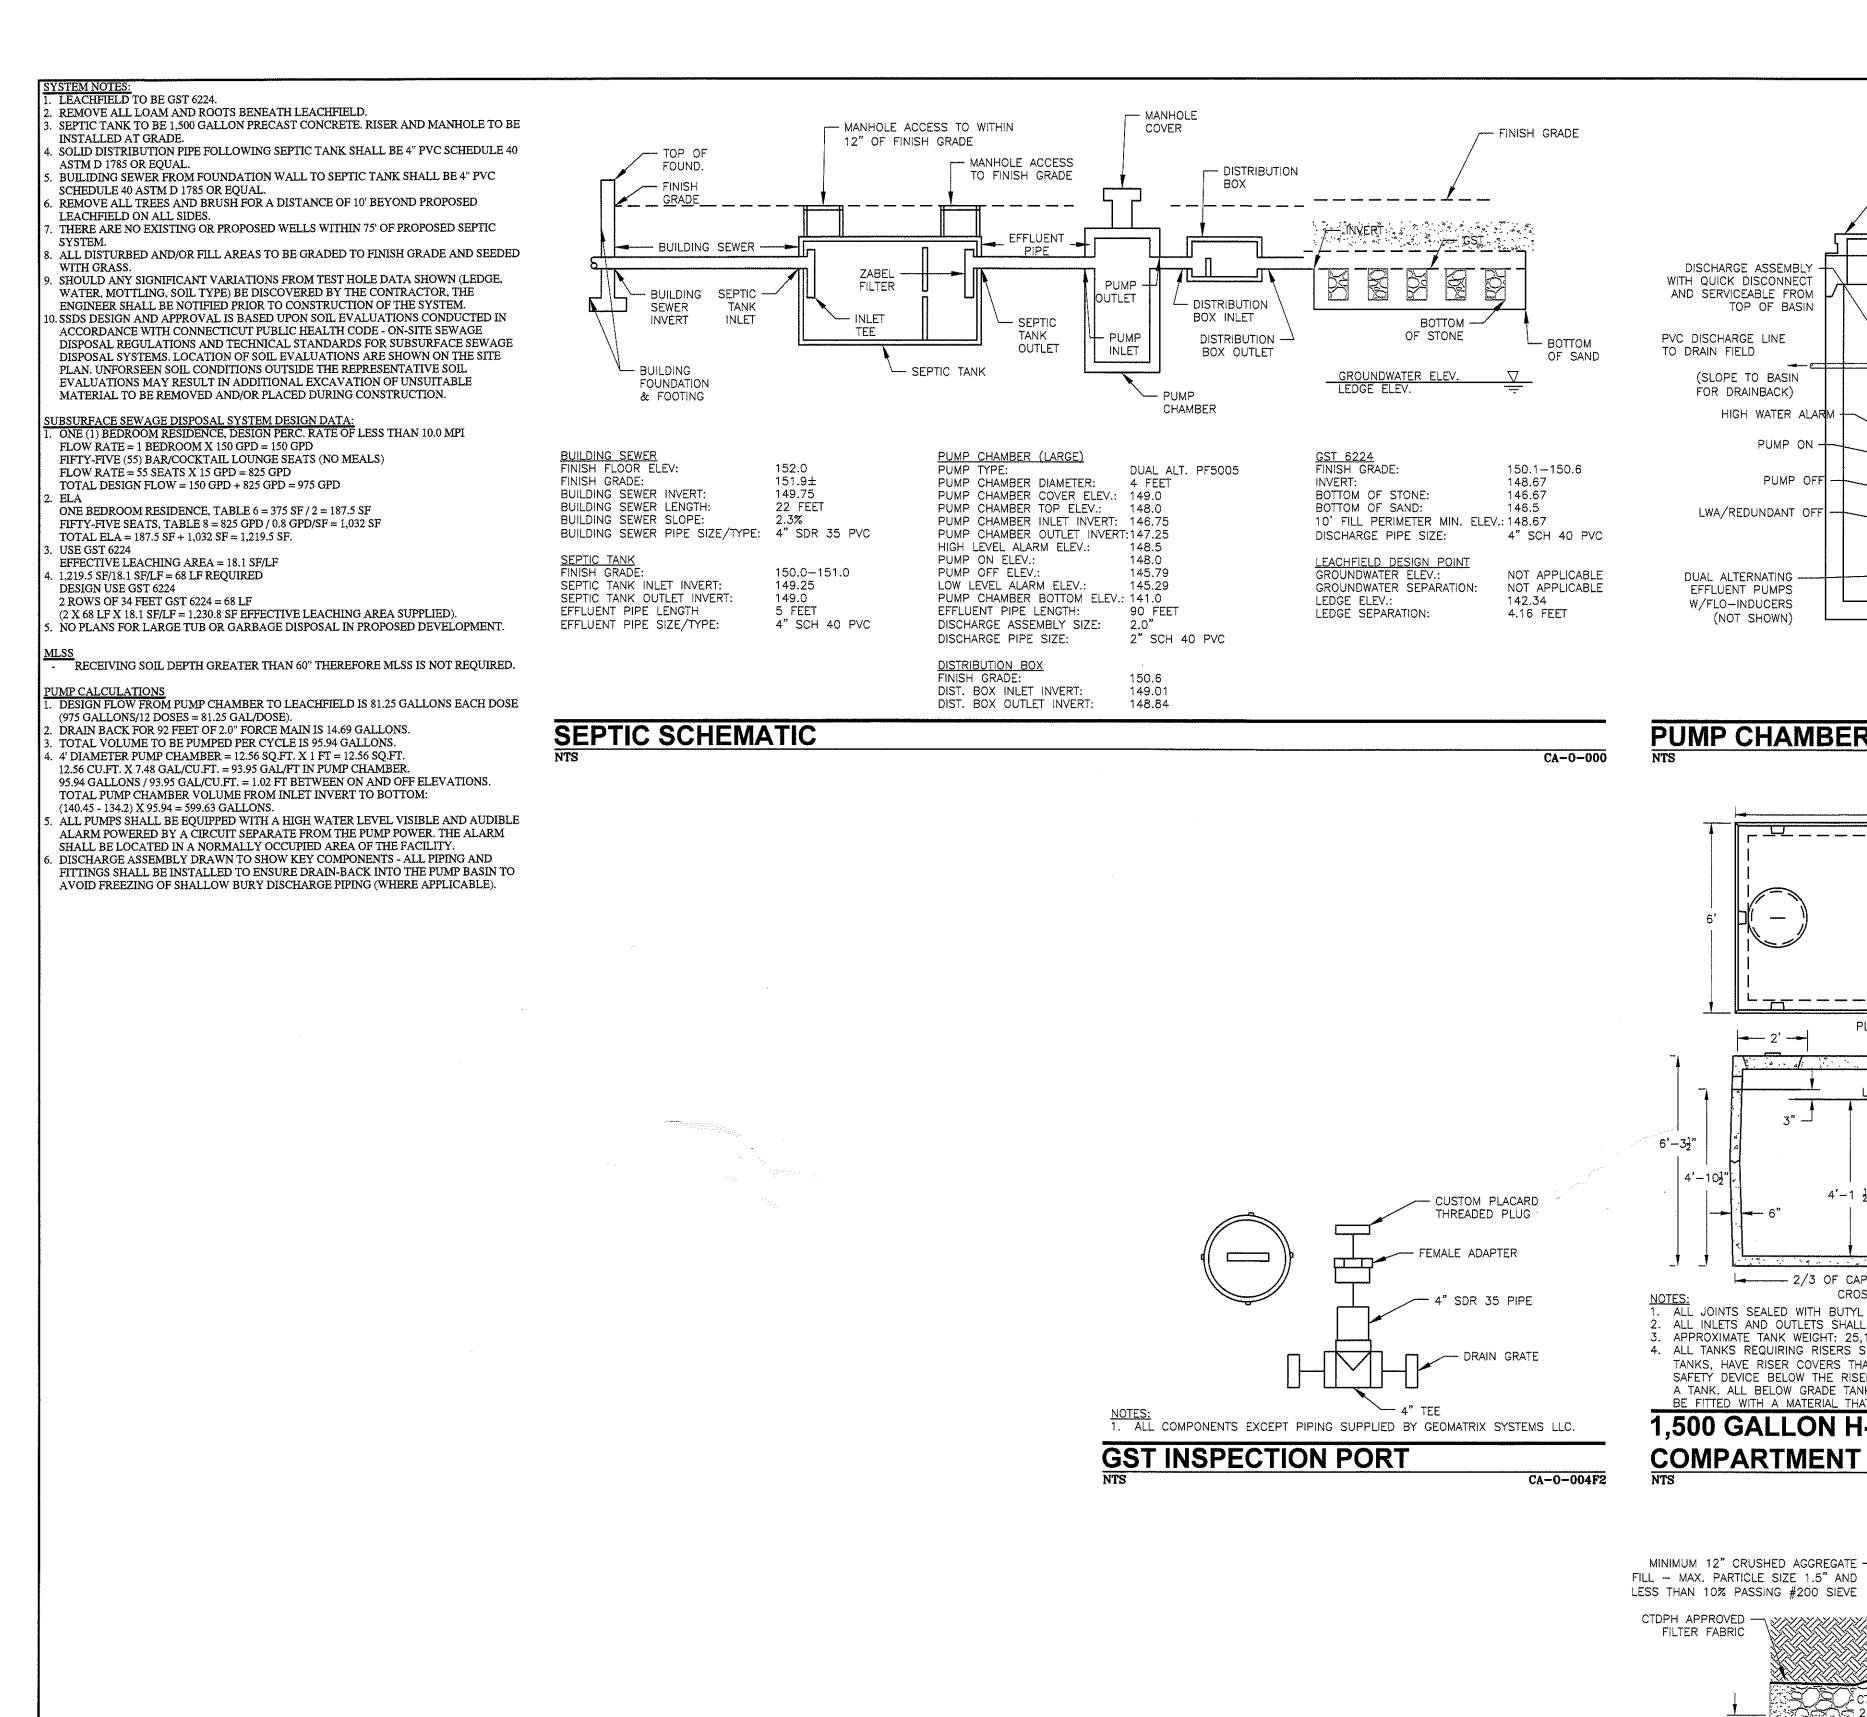
GRADING, DRAINAGE, & UTILITY PLAN

KINGDOM OF THE HAWK TASTING ROOM 113 PENDLETON HILL ROAD **MAP 122 LOT 2660** NORTH STONINGTON, CONNECTIC

PREPARED FOR KINGDOM OF THE HAWK, LI






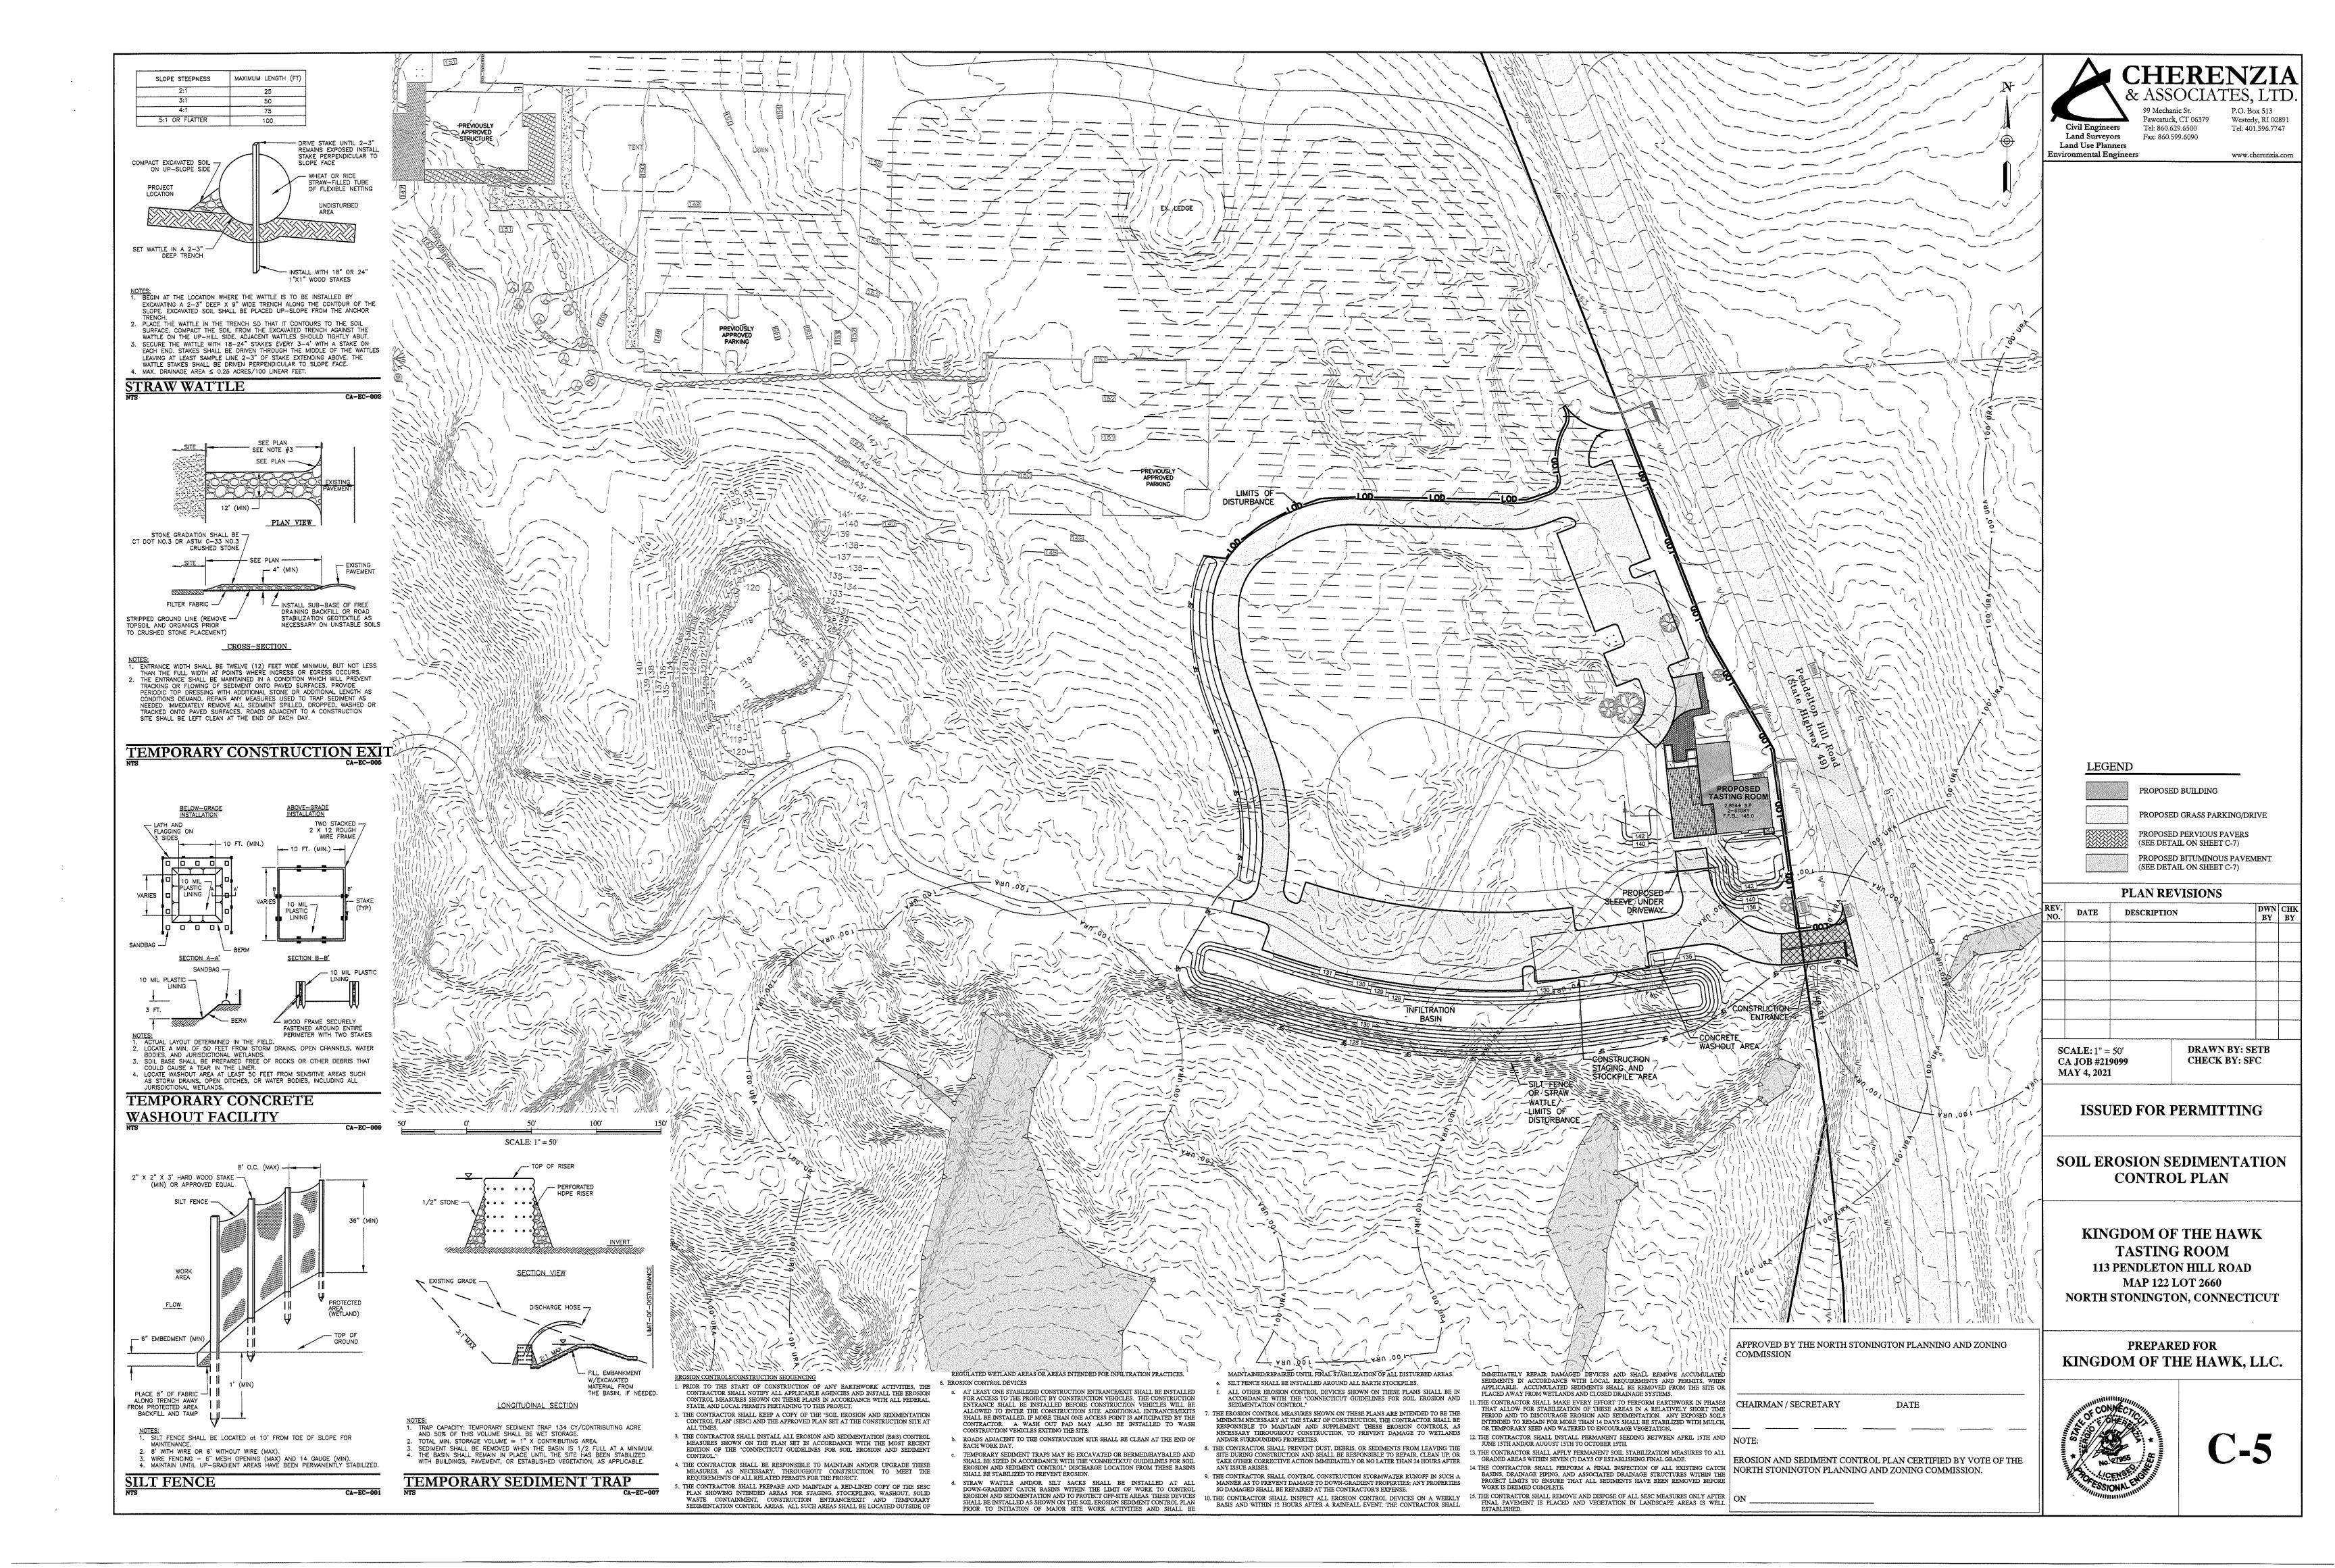


GRAVITY SEWER -


SEPTIC SLEEVE

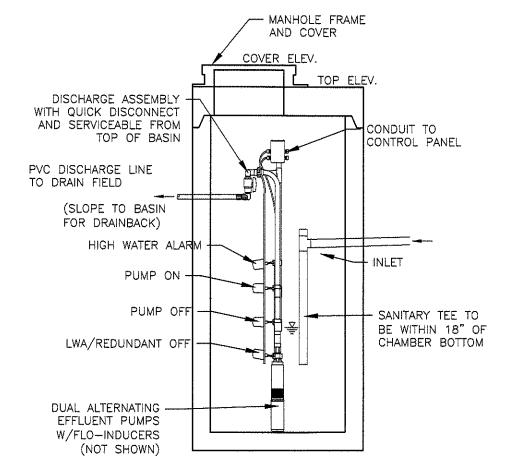

PUMP CHAMBER DETAIL

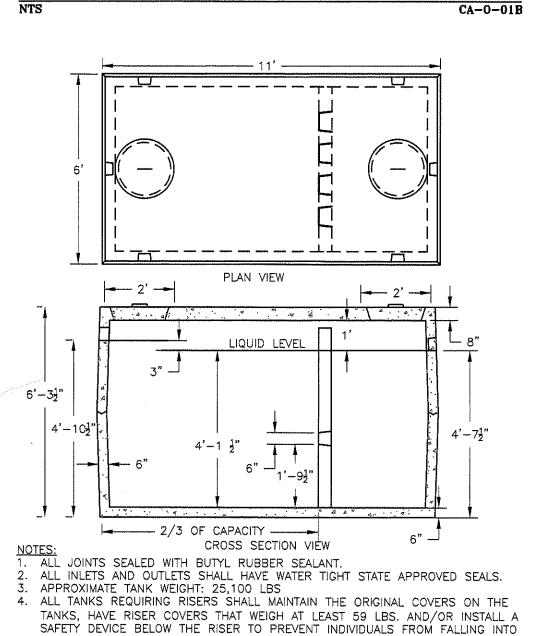

A TANK, ALL BELOW GRADE TANK OR RISER COVER HANDLES SHALL CONTAIN OR BE FITTED WITH A MATERIAL THAT CAN BE LOCATED WITH A METAL DETECTOR. ,500 GALLON H-20 TWO COMPARTMENT SEPTIC TANK

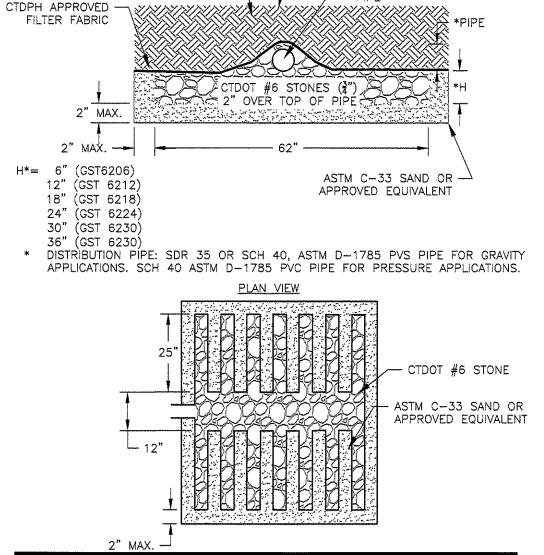

FINISHED GRADE SHALL BE PITCHED TO SHEET FLOW

STORMWAYER AWAY FROM SYSTEM



SITE INVESTIGATION FOR A SUBSURFACE SEWAGE DISPOSAL SYSTEM Property Addresss: <u>113 Pendleton Hill Rd</u> Town: North Stonington

DEEP TEST PIT DATA/SOIL DESCRIPTIONS

DATE: 2/11/2021 (Record all Test Pits)				
TEST PIT:	1	TEST PIT; 2	TEST PIT: 3	TEST PIT: 4
0-108 Fill		0-90 Fill	0-80 Fill	0-84
Unsuitable		Unsuitable	Unsuitable	Unsuitable
Mottles:		Mottles:	Mottles:	Mottles:
GW:		GW:	GW:	GW: 74
Ledge:		Ledge:	Ledge:	Ledge:
Roots:		Roots: to	Roots to:	Roots to:
Restrictive:		Restrictive:	Restrictive:	Restrictive:
TEST PIT: 5		TEST PIT: 6	TEST PIT: 7	
0-84 Fill		0-24 Top Soil	near a catch basin (needs	
Unsuitable		24-54 Light Br, med sand	to be relocated).	
		54-87 Gray Tan, Med	0-54 Fill	
		coarse with cobbles	54-86	
		The street side of the test		
		hole witnessed faint line of fill.		
Mottles:		Mottles:	Mottles:	
GW:		GW:	GW:	-
Ledge:		Ledge:	Ledge;	
C 4 - 4 -				4

Restrictive


GROUNDWATER TABLE (Near max., below max., etc.):____ SOIL MOISTURE (High, medium, low, etc.): _____

Restrictive:

PERCOLATION TEST RESULTS PERCOLATION TEST 2/10/2021 WITNESSED BY SERGIO F. CHERENZIA, PE FROM CHERENZIA &

ASSOCIATES, LTD. TIME INTERVAL DEPTH (IN) PERC. RATE (MIN/IN) 0.00 1.67 2.00 4.00 6.67 10.00 17.5 6.67 TOTAL DEPTH 24 INCHES FROM ORIGINAL GRADE

AVERAGE PERC RATE: 4.43 MAXIMUM PERC RATE: 10.00 " HANDLE

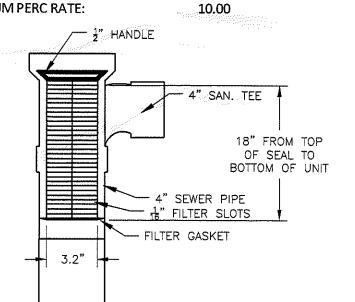

ZABEL FILTER DETAILS

CA-0-007A

CA-0-02B

DETAILS SHEET 1 KINGDOM OF THE HAWK

TASTING ROOM 113 PENDLETON HILL ROAD MAP 122 LOT 2660 NORTH STONINGTON, CONNECTICUT

ISSUED FOR PERMITTING

PLAN REVISIONS

DRAWN BY: SETB

CHECK BY: SFC

DESCRIPTION

DATE

SCALE: ---

MAY 4, 2021

CA JOB #219099

PREPARED FOR KINGDOM OF THE HAWK, LLC.



P.O. Box 513

Westerly, RI 02891

www.cherenzia.com

Tel: 401.596.7747

Pawcatuck, CT 06379


Tel: 860.629.6500

Fax: 860.599.6090

Land Surveyors


Land Use Planners

Environmental Engineers

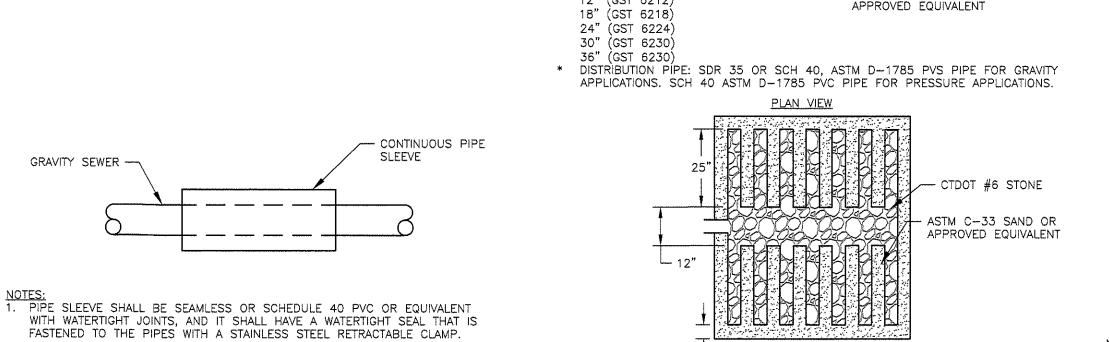

CA-0-040


MINIMUM 12" CRUSHED AGGREGATE -

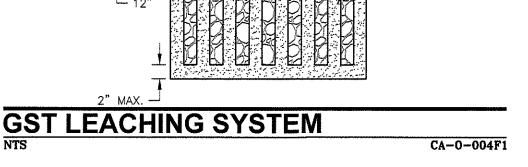

(5) 5" OUTLETS — NOTES:
1. MINIMUM 3 S.F. BOTTOM AREA

DB-5 DISTRIBUTION BOX

(3) 5" OUTLETS —

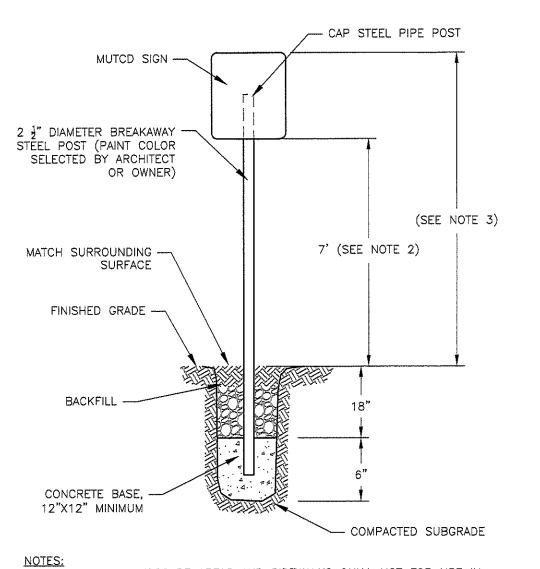


NOTES:

1. FOR USE IN LANDSCAPE AREAS AND SIDEWALKS ONLY. NOT FOR USE IN PARKING LOTS OR TRAVELED WAYS. 2. FOR ADA SIGNAGE, THIS DIMENSION SHALL BE 5' (MIN.) 3. FOR ADA SIGNAGE, THIS DIMENSION SHALL BE 8' (MAX.)

SIGN POST

CA-SS-001

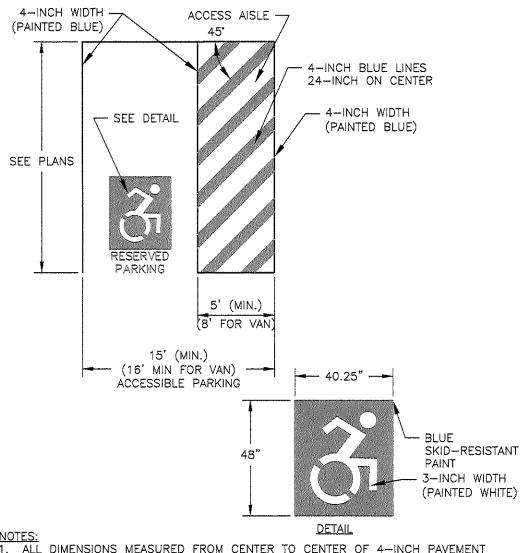


. ALL DIMENSIONS MEASURED FROM CENTER TO CENTER OF 4-INCH PAVEMENT

2. 8-FOOT STALL WIDTH REFERS TO 8-FEET BETWEEN CENTER LINE OF PAVEMENT

3. ALL SLOPES THROUGHOUT THE ACCESSIBLE PARKING AND AISLE AREAS SHALL NOT EXCEED 2%


ADA SPACES CA-SS-004CT

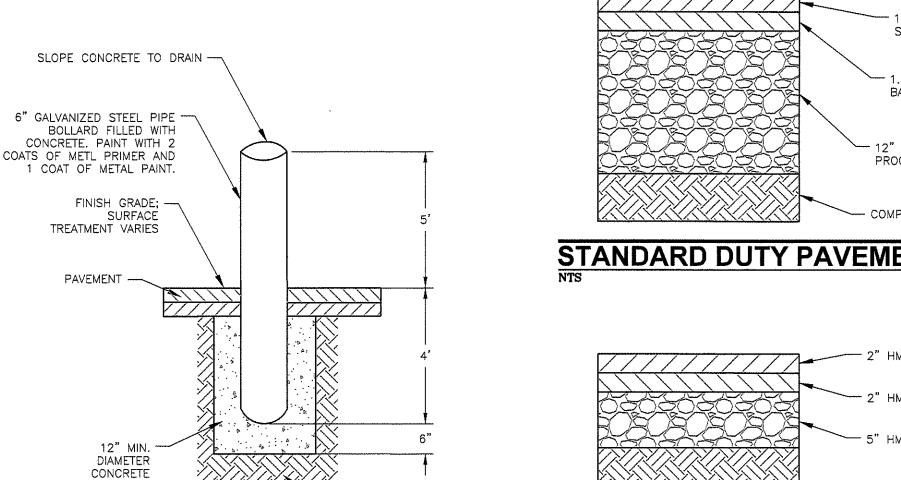


- COMPACTED SUBGRADE

BOLLARD CA-M-004


ENCASEMENT

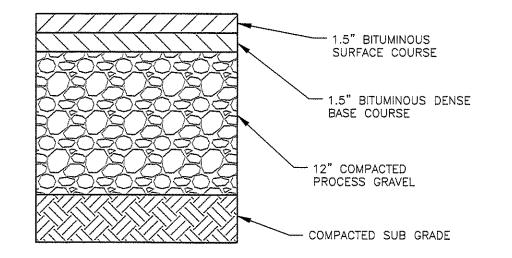

STANDARD DUTY PAVEMENT CA-RD-001

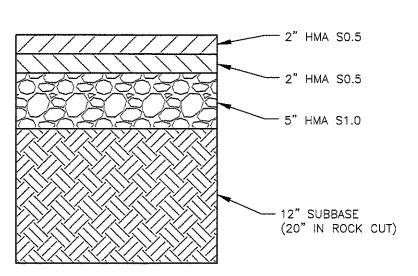

CTDOT BITUMINOUS PAVEMENT

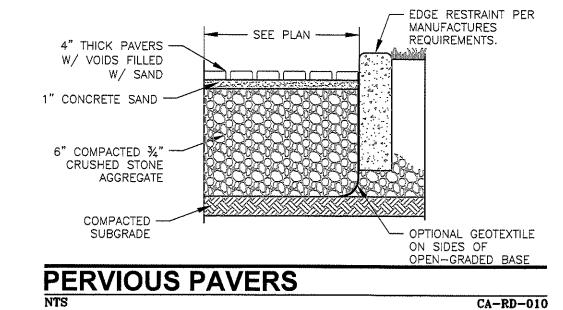

CA-RD-032

SEEDING GUIDELINES

FINAL STABILIZATION OF ALL DISTURBED AREAS, UNLESS OTHERWISE NOTED, SHALL BE LOAMED AND SEEDED. LOAM SHALL BE PLACED AT A MINIMUM COMPACTED DEPTH OF 4 INCHES. TEMPORARY VEGETATIVE MEASURES SHALL CONSIST OF AN ANNUAL OR PERENNIAL RYE GRASS WITH RECOMMENDED SEEDING DATES BEING FROM MARCH 1 THROUGH JUNE 30 AND/OR AUGUST 1 THROUGH OCTOBER 15.


PROPOSED COVER MATERIAL SHOULD BE SPREAD EVENLY OVER THE ENTIRE SITE IN A MINIMUM 4-INCH LIFT VIA BULLDOZER/BUCKET LOADER. THE SEED BED SHOULD BE SMOOTH AND FIRM PRIOR TO SEEDING. THE FOLLOWING SEED MIXTURES SHOULD BE USED AS NOTED.

SEED MIXTURE

LBS/ACRE KENTUCKY BLUEGRASS PERENNIAL RYEGRASS

THE PREFERRED TIME FOR SEEDING THE COOL SEASON MIXTURE IS LATE SUMMER. SOIL AND AIR TEMPERATURES ARE IDEAL FOR SEED GERMINATION AND SEEDLING REDUCED BECAUSE SEEDS OF MANY WEED SPECIES GERMINATE EARLIER IN THE GROWING SEASON. ADDITIONALLY, HERBICIDE USE IS GREATLY REDUCED. HOWEVER, SEEDING MAY BE DONE AT ANY OF THE ABOVE NOTED

NEWLY SEEDED AREAS SHOULD BE MULCHED TO INSURE ADEQUATE MOISTURE FOR SUCCESSFUL TURF ESTABLISHMENT AND TO PROTECT AGAINST SURFACE MOVEMENT OF SEDIMENT-BOUND ARGOCHEMICALS AND SOIL EROSION. APPLY GOOD QUALITY STRAW OR HAY AT A RATE OF 2 BALES/1000 SQ. FT. OTHER COMMERCIALLY AVAILABLE MULCHES CAN BE USED.

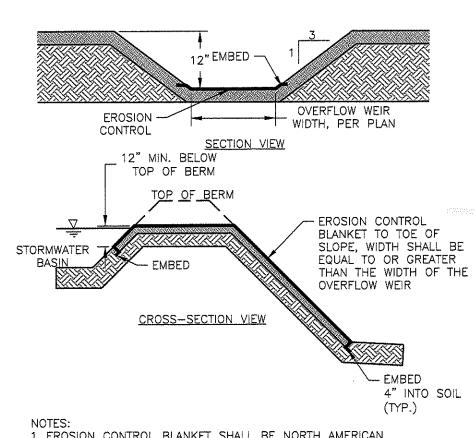

1. EROSION CONTROL BLANKET SHALL BE NORTH AMERICAN GREEN PRODUCTS P300 OR APPROVED EQUIVALENT. 2. EROSION CONTROL BLANKET SHALL BE INSTALLED PER MANUFACTURER'S REQUIREMENTS.

EARTHEN EMERGENCY SPILLWAY

MIN 12" MIN. - 3:1 (MAX) 3:1 (MAX) — - CONTINUOUS COMPACTED CLAY CORE STORMWATER BASIN PER PLANS AS REQ'D FOR - CONSTRUCTION 12" MIN.

STORMWATER BASIN EMBANKMEN

6" SANDY LOAM STORMWATER -TOPSOIL PONDING AREA — EMERGENCY OVERFLOW BERM, SEE TABLE FOR PROPOSED -GRADE ELEVATIONS ANY ORGANIC LAYER ---- UNCOMPACTED AND/OR SILT LOAM SUBGRADE MATÉRIAL SHALL BE RREMOVED AND REPLACED WITH C33 "CONCRETE SAND"

TO ENSURE THE LONG-TERM FUNCTION AND VALUE OF AREAS PROPOSED FOR INFILTRATION, INCLUDING INFILTRATION AREAS, THE CONTRACTOR SHALL EXERCISE THE FOLLOWING BEST MANAGEMENT PRACTICES THROUGHOUT CONSTRUCTION:


- 1. THESE AREAS SHALL NOT BE USED FOR TEMPORARY CONSTRUCTION SEDIMENTATION CONTROL, SEDIMENTATION BASINS, OR DEWATERING AREAS.

 2. THESE AREAS SHALL REMAIN OFF—LINE UNTIL THE ENTIRE CONSTRUCTION AREA CONTRIBUTING TO THESE AREAS HAS BEEN STABILIZED WITH BUILDINGS, BUILDING FOUNDATIONS, PAVEMENT, OR VEGETATION, AS APPLICABLE. 3. STORMWATER RUNOFF DURING CONSTRUCTION SHALL BE DIRECTED AWAY FROM THESE AREAS TO THE GREATEST EXTENT PRACTICABLE. WHERE NOT FEASIBLE, THE CONTRACTOR SHALL INSTALL ADDITIONAL EROSION CONTROLS UP-GRADIENT OF THESE AREAS TO PREVENT SEDIMENTATION OF THESE AREAS DURING
- 4. THE SUBGRADE BELOW THESE AREAS SHALL NOT BE COMPACTED; THEREFORE, THE CONTRACTOR SHALL RESTRICT ACCESS TO THESE AREAS BY HEAVY EQUIPMENT AND SHALL NOT USE THESE AREAS FOR MATERIALS STOCKPILES.

 5. EXCAVATION AND CONSTRUCTION OF THESE AREAS SHALL BE PERFORMED USING
- HAND OR HYDRAULIC EQUIPMENT TO ENSURE THAT THE NATURAL FILTRATION EARTH MATERIAL IS NOT DISTURBED OR OTHERWISE COMPACTED. 6. UPON COMPLETION OF CONSTRUCTION OF ANY OF THESE AREAS, THE CONTRACTOR SHALL INSTALL EROSION CONTROL MEASURES TO PREVENT SILTATION OF THE FILTER MATERIALS.

INFILTRATION AREA

CA-D-012

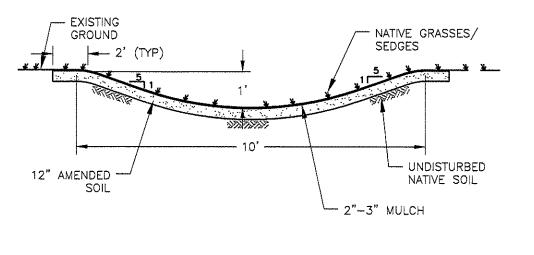

GRASSED SWALE

CA-D-026

PLAN REVISIONS DATE DESCRIPTION DRAWN BY: SETB SCALE: N.T.S. CHECK BY: SFC CA JOB #219099 MAY 4, 2021

P.O. Box 513

Westerly, RI 02891

www.cherenzia.com

Tel: 401.596.7747

Pawcatuck, CT 06379

Tel: 860.629.6500

Fax: 860.599.6090

Civil Engineers

Land Use Planners

Environmental Engineers


ISSUED FOR PERMITTING

DETAILS SHEET 2

KINGDOM OF THE HAWK TASTING ROOM 113 PENDLETON HILL ROAD MAP 122 LOT 2660 NORTH STONINGTON, CONNECTICUT

PREPARED FOR KINGDOM OF THE HAWK, LLC.



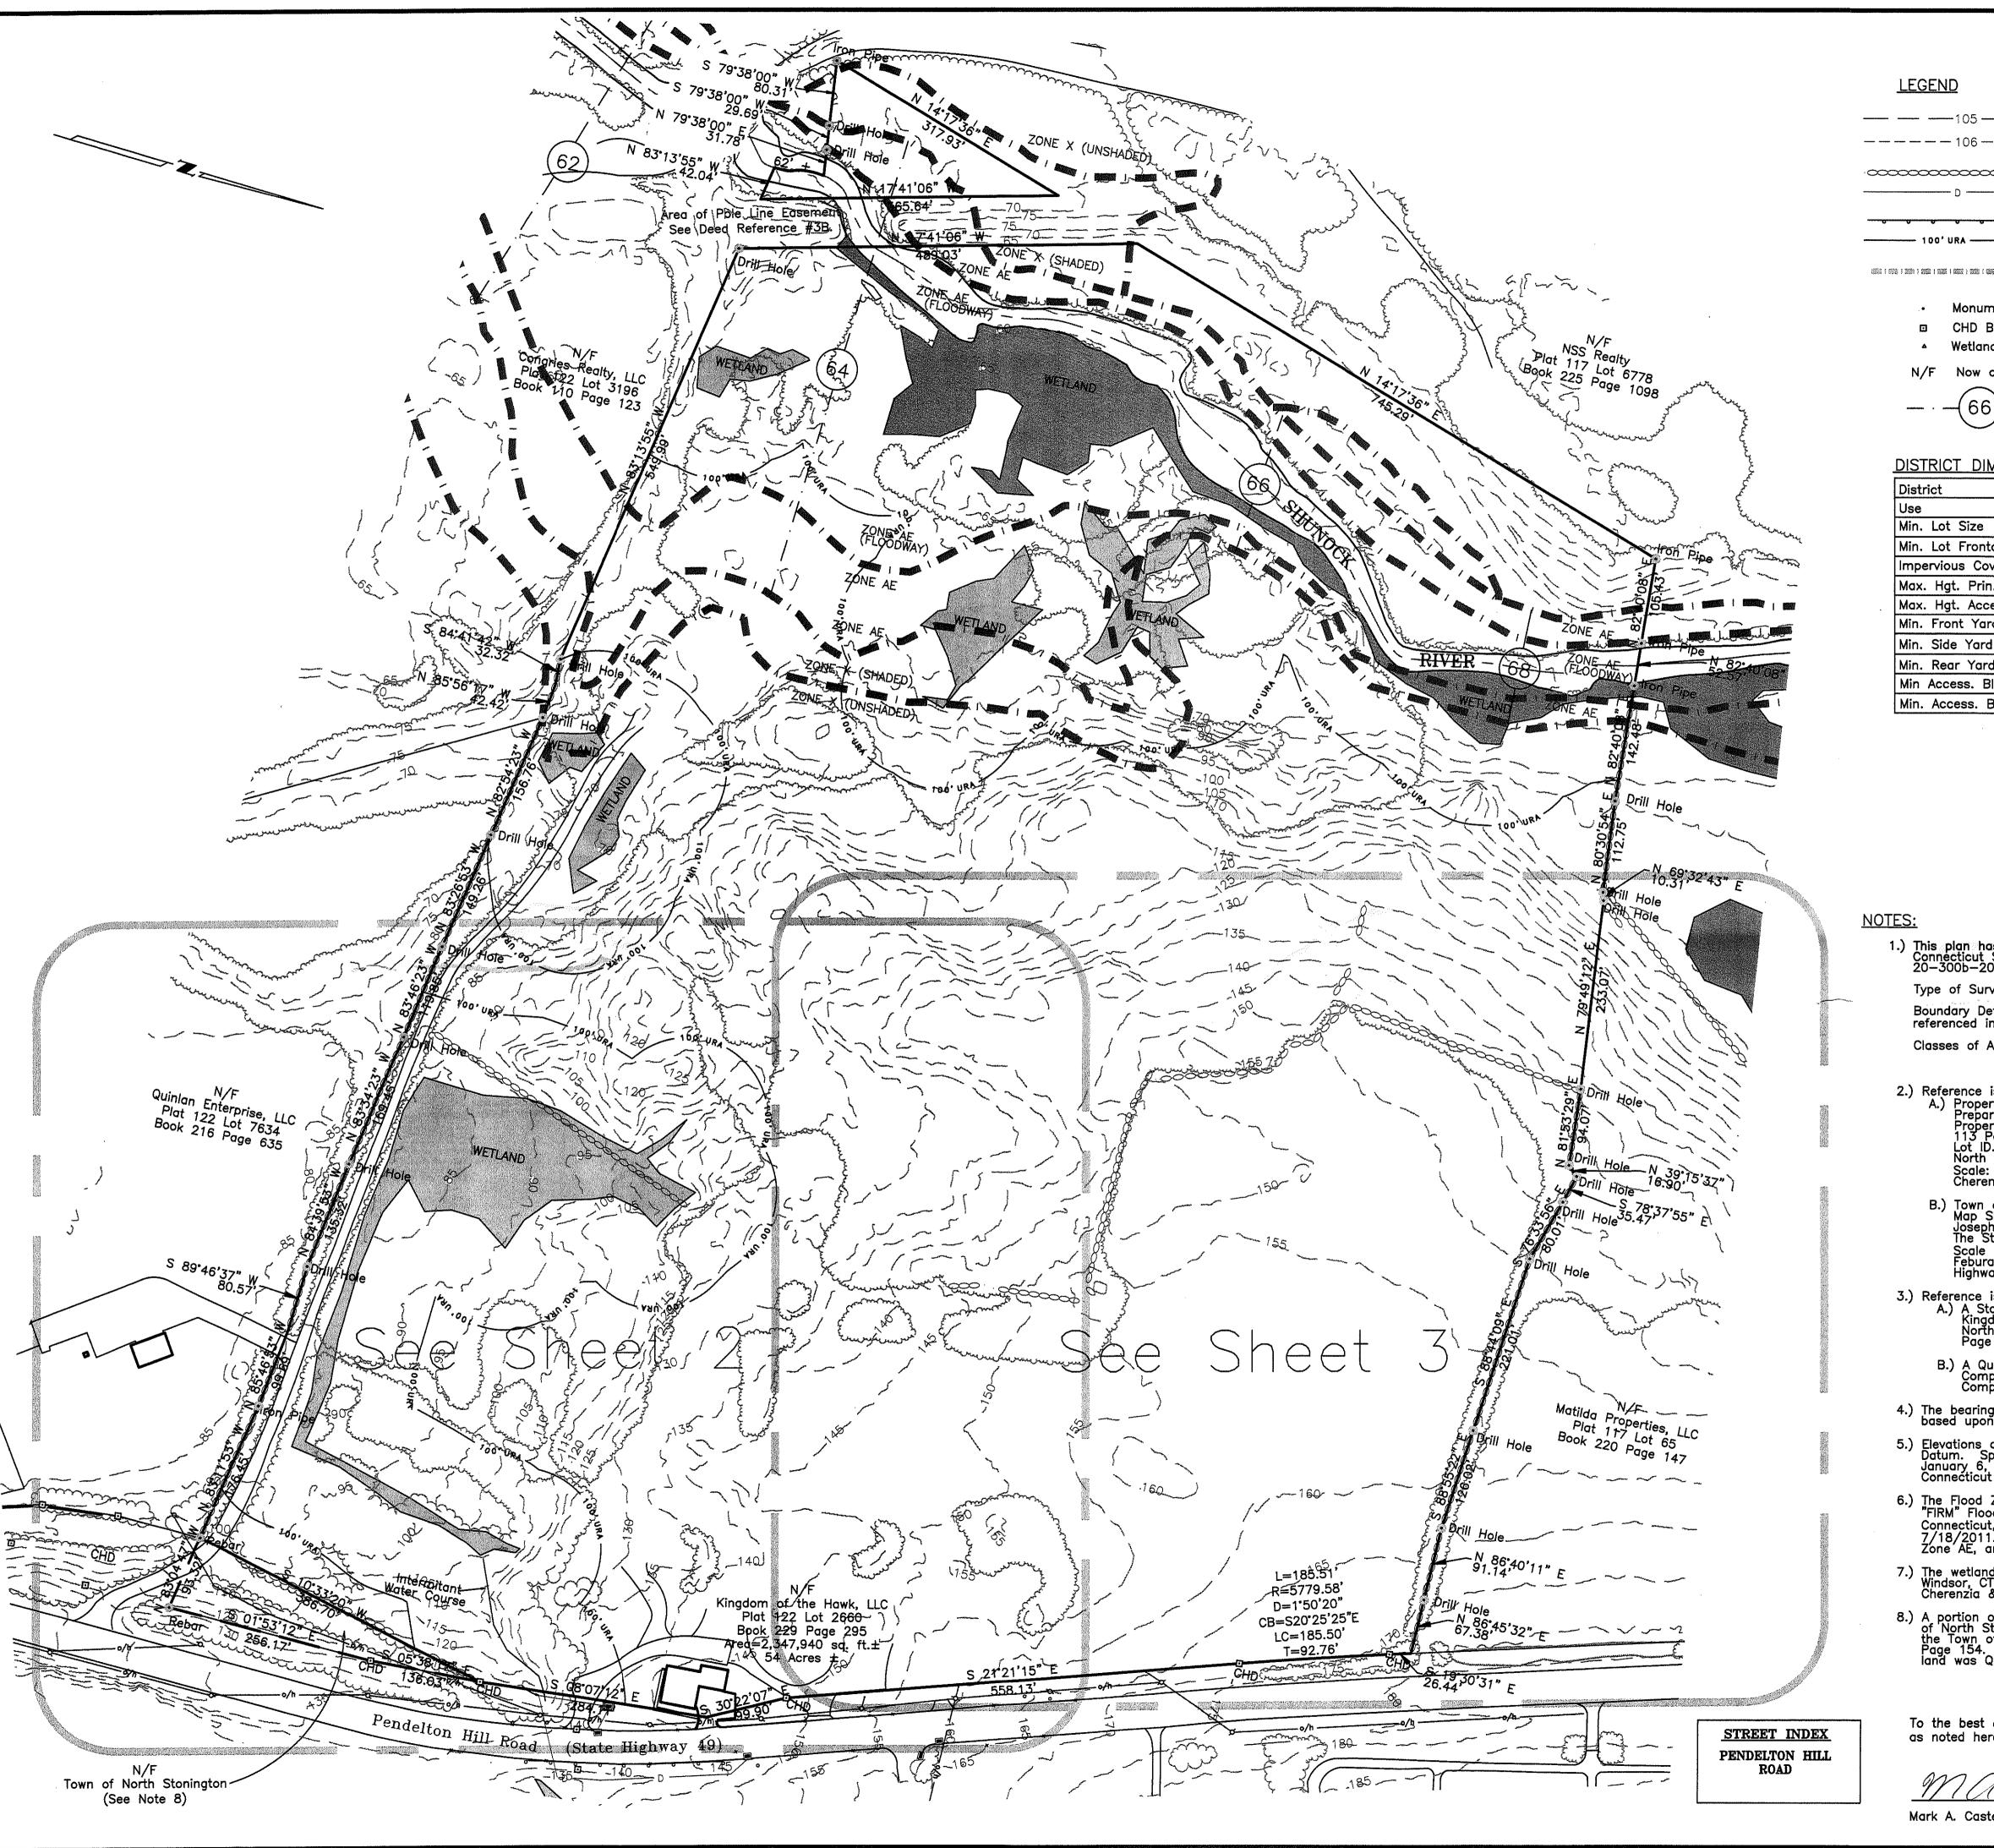

—— —— 105 — — — Major Contours — 5' Intervals ----- 106 ---- Minor Contours - 1' Intervals (sheets 2 & 3) Stone wall

Existing Storm Drain

FEMA Flood Hazard Line

- CHD Bound (Connecticut Highway Department)
- ▲ Wetland Flag

N/F Now or Formerly

Flood Study Transect Line

DISTRICT DIMENSIONAL REGULATIONS

District	EDD
Use	Economic Development
Min. Lot Size	200,000 sq. ft.
Min. Lot Frontage	200 feet
Impervious Coverage %	70%
Max. Hgt. Prin. Bldg.	50 Feet
Max. Hgt. Access. Bldg.	N/A
Min. Front Yard Depth	35 feet
Min. Side Yard Depth	20 feet
Min. Rear Yard Depth	20 feet
Min Access. Bldg Side	N/A
Min. Access. Bldg. Rear	N/A

1.) This plan has been prepared pursuant to the regulations of Connecticut State Agencies, Sections 20-300b-1 through Type of Survey: Boundary Survey Boundary Determination Category: Resurvey based upon plans referenced in note #2A. Classes of Accuracy: A-2 Horizontal; T-2 & T-D Vertical

2.) Reference is hereby made to the following plans:


A.) Property Survey
Prepared for Great Wolf Resorts, Inc.
Property of James P. Crider & Gloria M. Crider
113 Pendelton Hill Road
Lot ID. 2741—76—2660
North Stonington, Connecticut
Scale: 1"=100' December 15, 2006
Cherenzia & Associates, LTD.

B.) Town of North Stonington
Map Showing Land Acquired From
Joseph P. Crider Jr. Et Al
The State of Connecticut — Route 49
Scale 1"=40'
Feburary 1962
Highway Commissioner: Howard S. Ives

- 3.) Reference is hereby made to the following Deeds:
 A.) A Statutory Form Warranty Deed from James P. Crider to Kingdom of the Hawk, LLC. Recorded in the Town of North Stonington Land Evidence Records under Book 229 Page 295 on February 22, 2019.
 - B.) A Quite Claim Deed from the Shore Line Electric Railway Company, granted to the Eastern Connecticut Power Company recorded April 21, 1920.
- 4.) The bearings and north arrow orientation depicted hereon are based upon the Connecticut State Plane Coordinate system of 1983.
- Elevations depicted hereon are based on the NAVD—88 Vertical Datum. Spot grades are based on a field survey performed January 6, 2020, contours shown are based on the 2016 Connecticut LIDAR data set.
- 6.) The Flood Zone Information depicted hereon as mapped is from "FIRM" Flood Insurance Rate Map, Town of North Stonington, Connecticut, New London County, Panel #: 09011C0411G effective 7/18/2011. Parcel lies partially within Special Flood Hazard Zone AE, and Flood Hazard Zones X and Unshaded X.
- The wetlands depicted hereon were delineated by Kleinfelder Windsor, CT and field survey located November, 2006 by Cherenzia & Associates, LTD.
- 8.) A portion of the old highway was to be Quit Claimed to The Town of North Stonington circa 1962, See Warrantee Deed recorded in the Town of North Stonington Land Evidence Records at Book 31, Page 154. No documents were found showing that this portion of land was Quit Claimed to the subject parcel.

To the best of my knowledge and belief this map is substantially correct as noted hereon.

Mark A. Castellanos, P.L.S. #70459

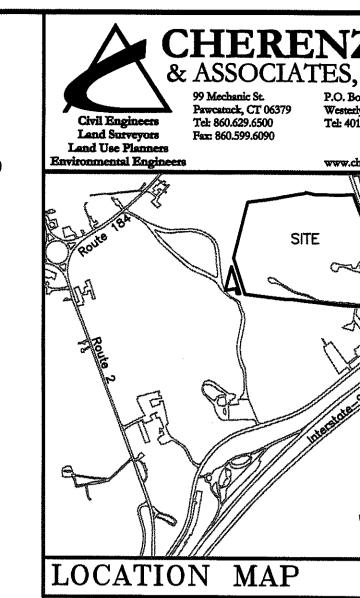

PLAN REVISIONS DESCRIPTION

SCALE: 1"=100' CA JOB # 219099 JANUARY 22, 2020

> COMPREHENSIVE BOUNDA & TOPOGRAPHIC SURVE

DRAWN BY:

CHECK BY: N

OVERALL BOUNDARY

113 PENDELTON HILL ROAL NORTH STONINGTON, CONNECT PLAT 122 LOT 2660

PREPARED FOR KINGDOM OF THE HAWK,



Sheet 1

CHERENZ ASSOCIATES



LOCATION MAP

See Sheet 1 for Legend & Notes

PLAN REVISIONS

DESCRIPTION

COMPREHENSIVE BOUNDAR'
& TOPOGRAPHIC SURVEY

DRAWN BY: TW CHECK BY: MA


EXISTING CONDITIONS


113 PENDELTON HILL ROAD NORTH STONINGTON, CONNECTION PLAT 122 LOT 2660

PREPARED FOR KINGDOM OF THE HAWK, I



Sheet 2 of CHERENZIA ASSOCIATES,

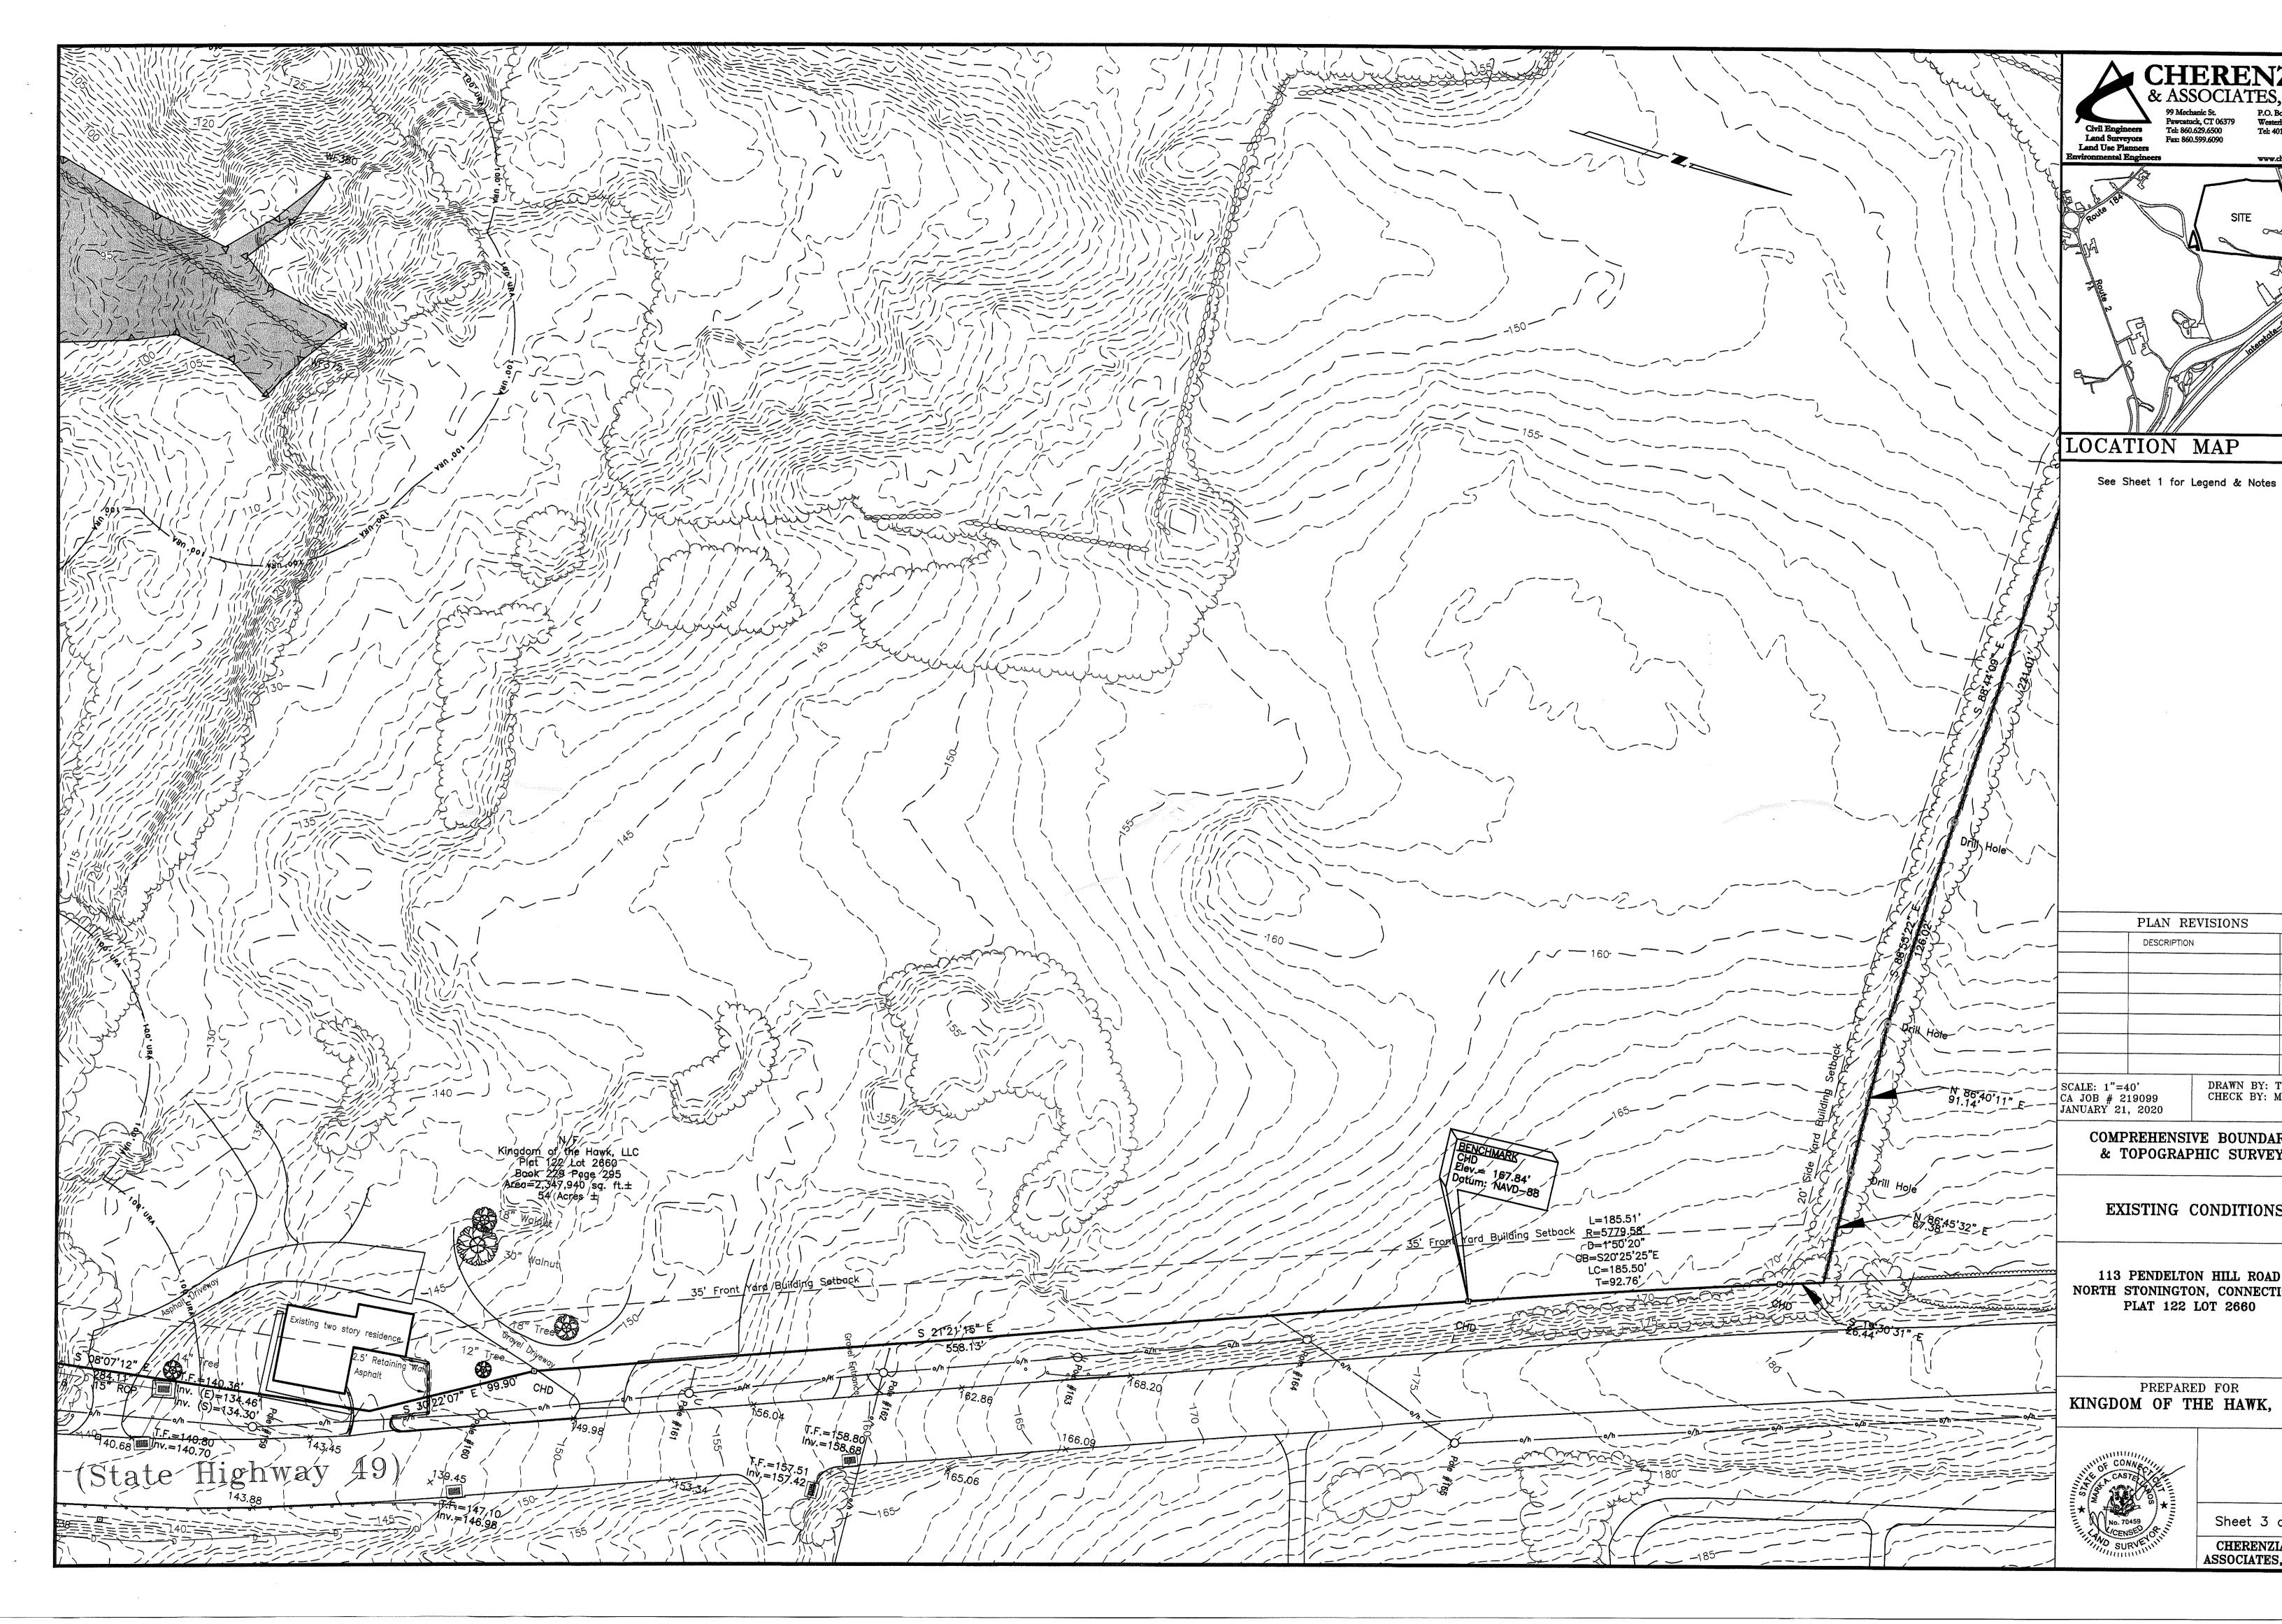

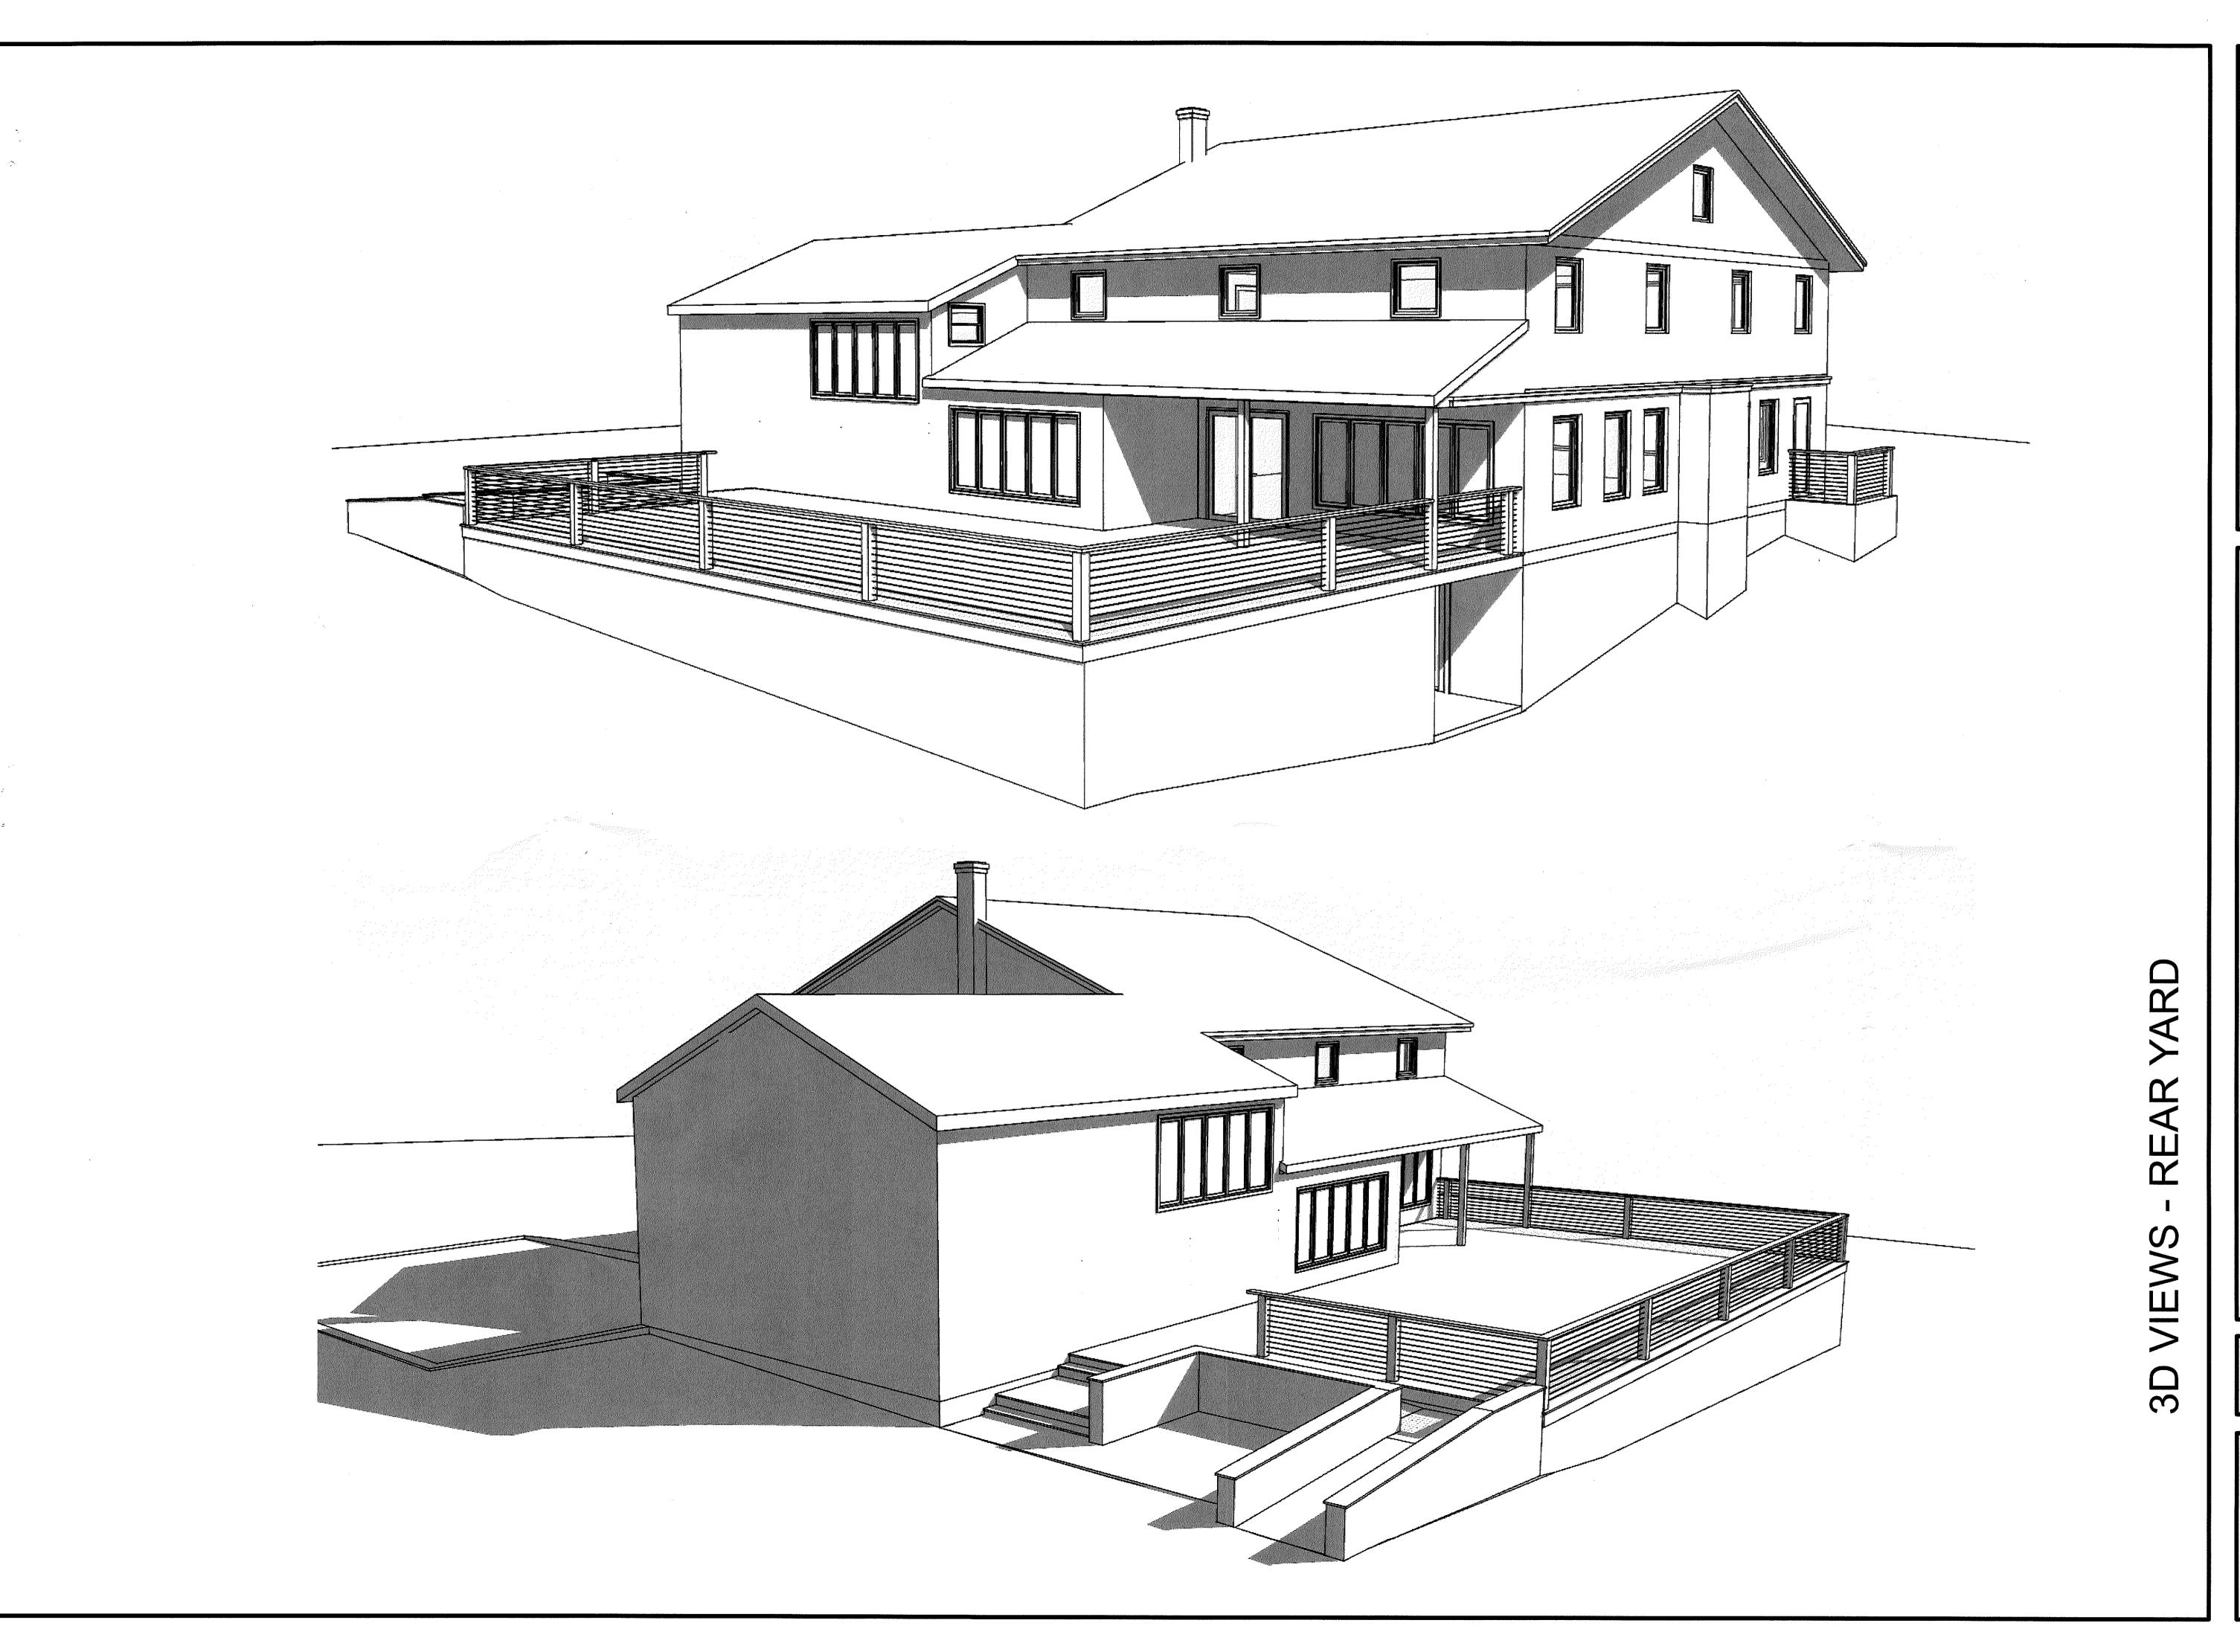

TOWN ZONING COMMISION SUBMISSION


OOS NMOZ NMOL

Scale 1/8"=1'-0"

SL

5-6-21

received

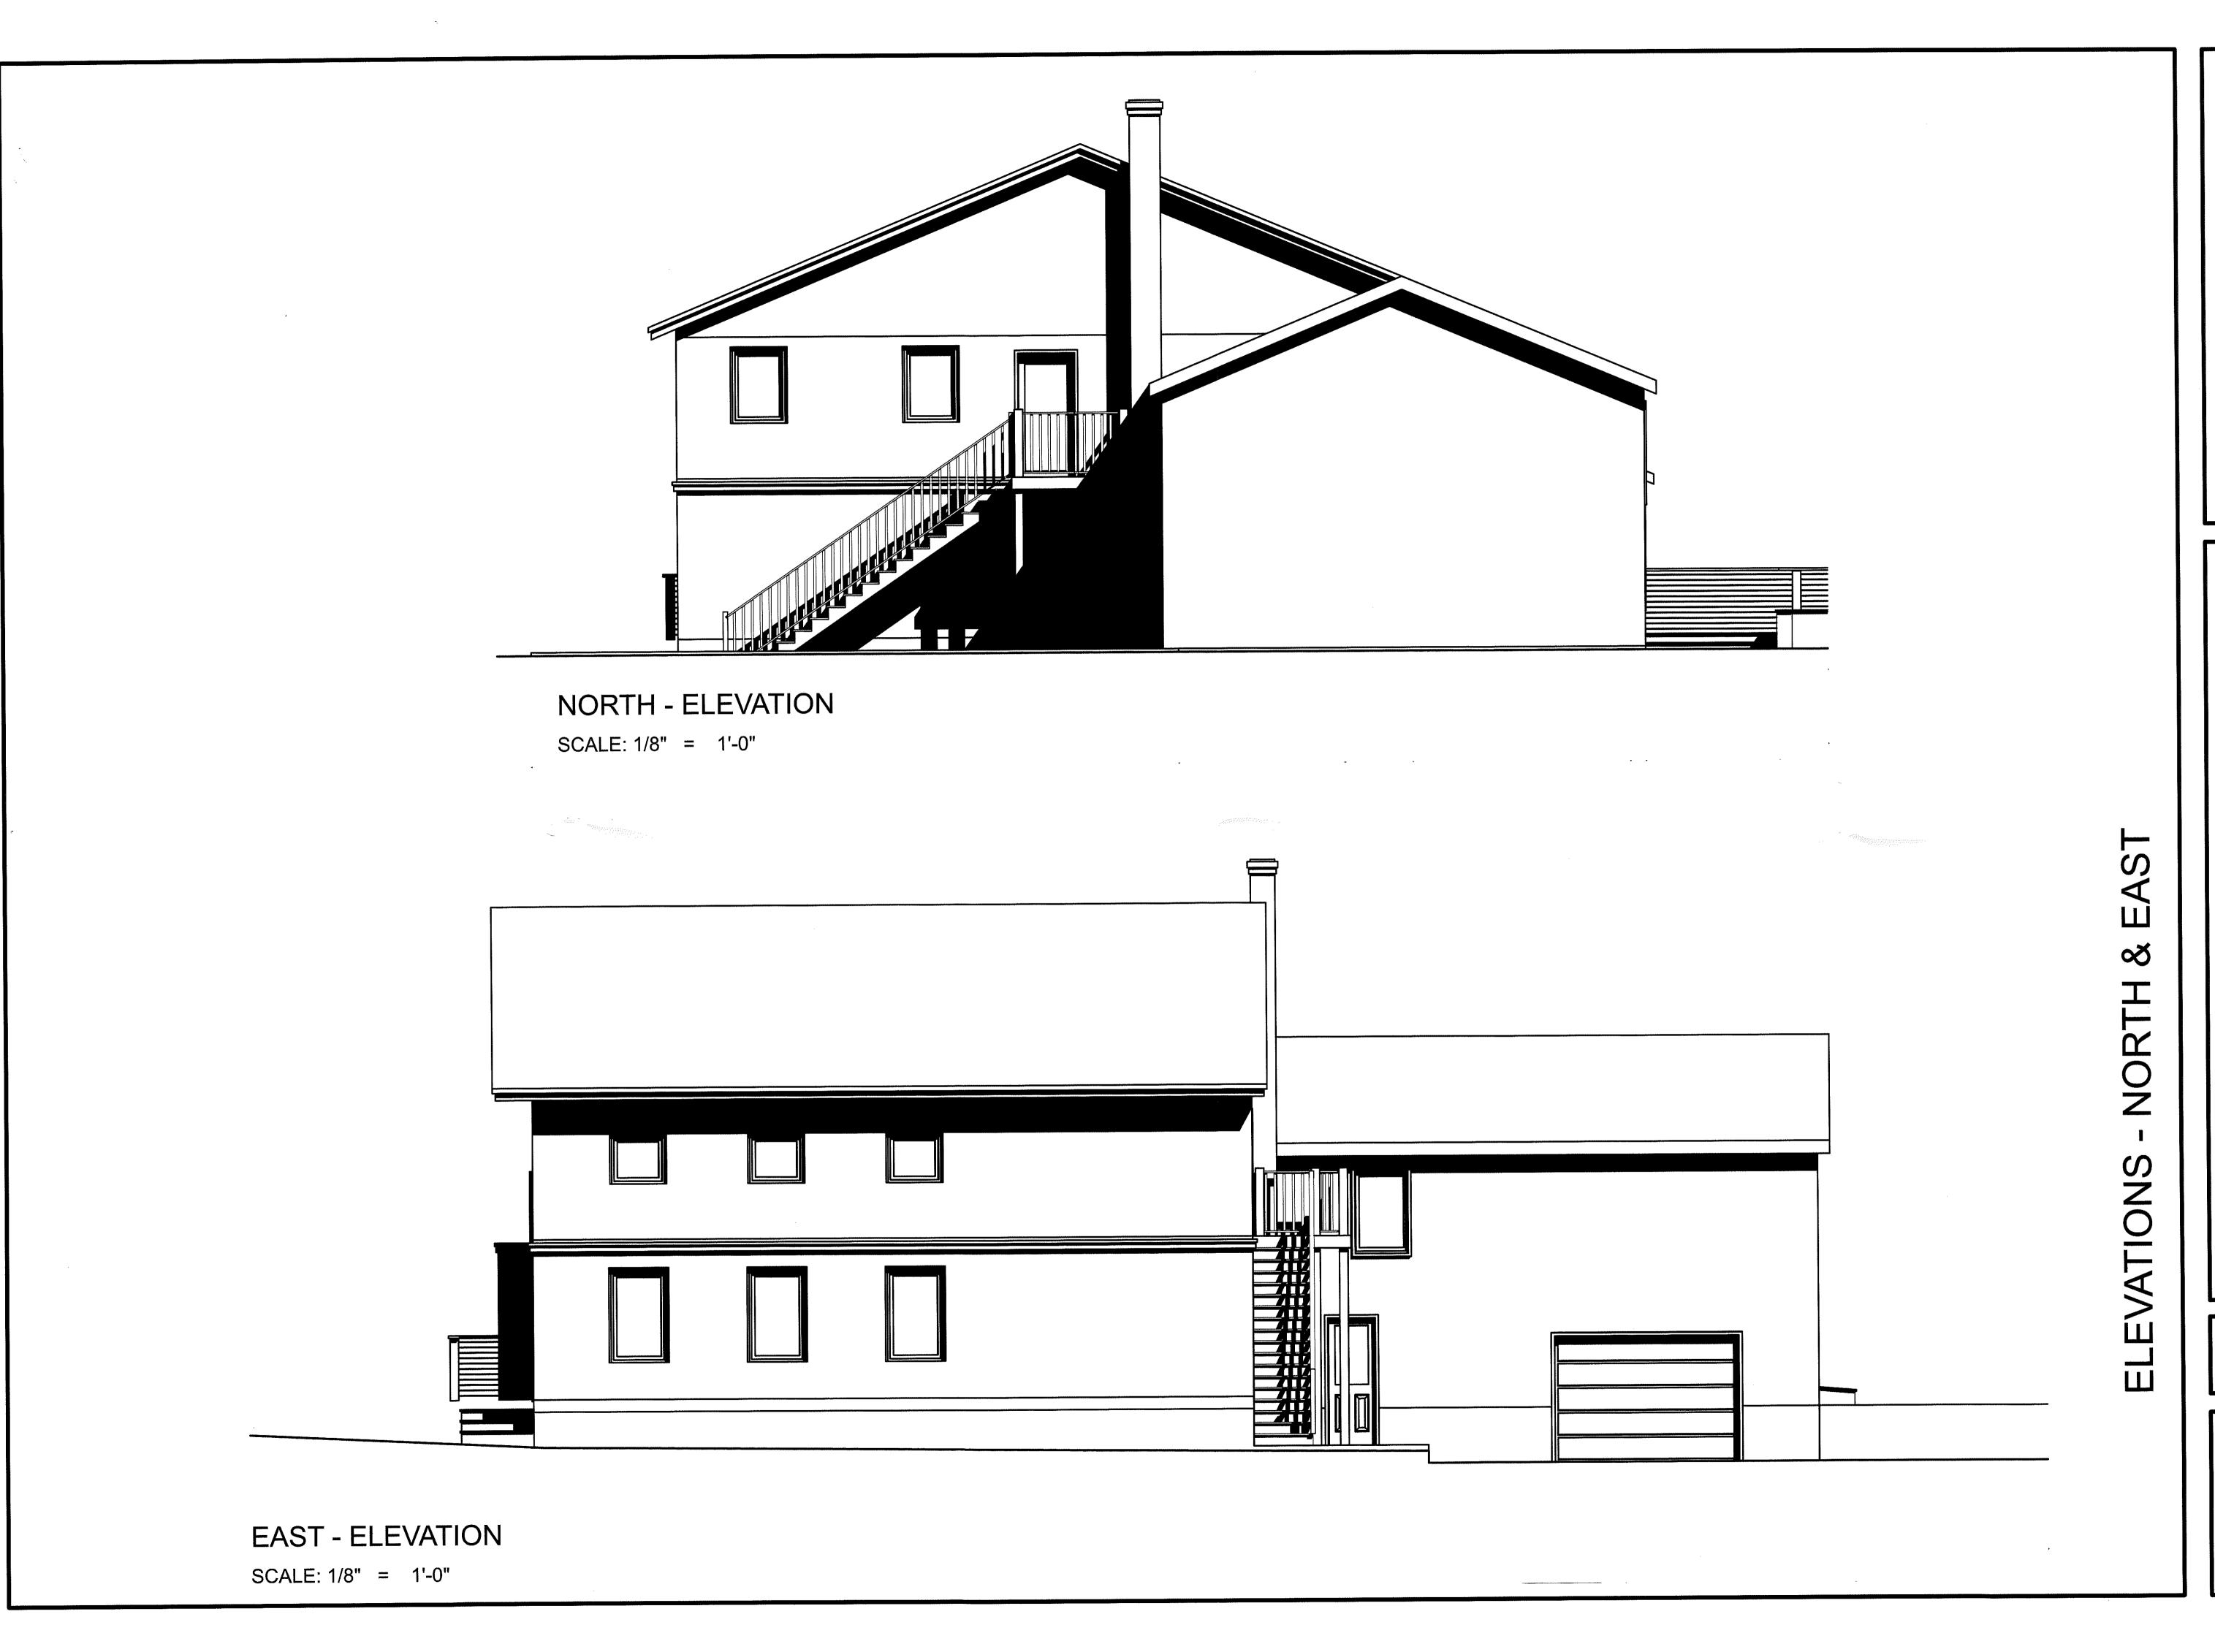


IGDOM OF THE HAW!
HOUSE

TOWN ZONING COMMISION SUBMISSION

Scale 1/8"=1'-0" 5-6-21

SD

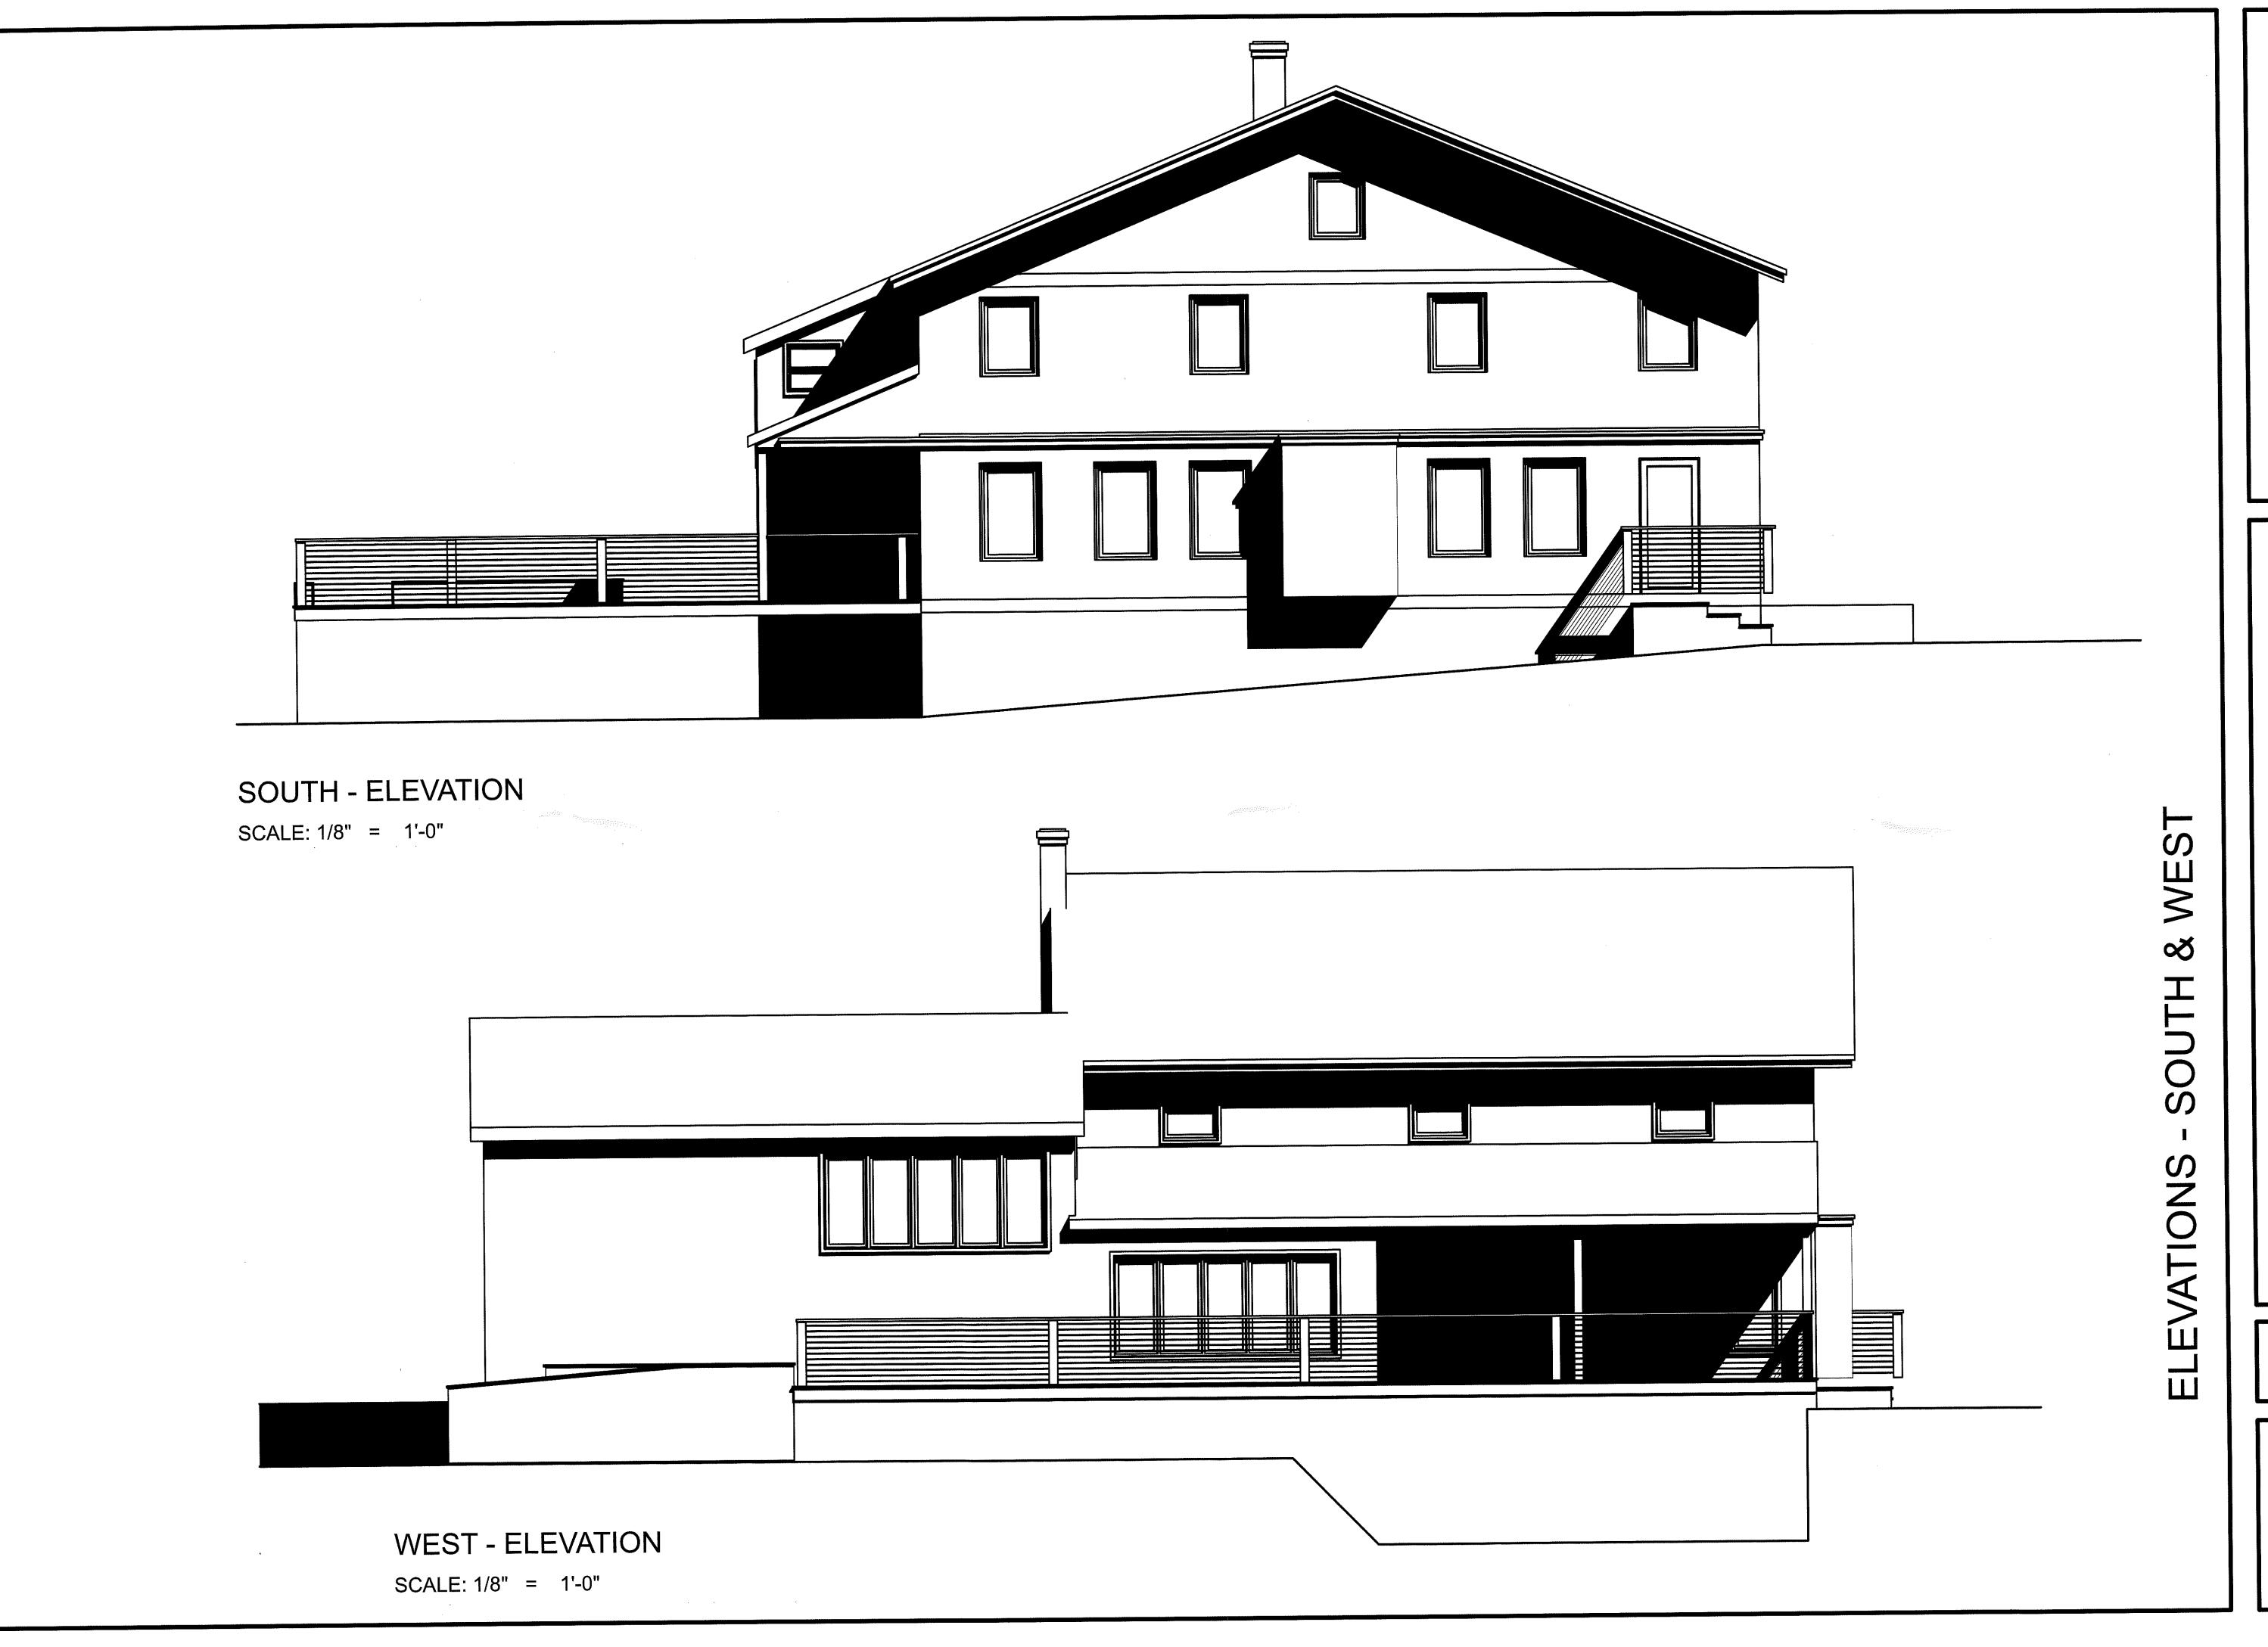



NGDOM OF THE HAWK
HOUSE

TOWN ZONING COMMISION SUBMISSION

Scale 1/8"=1'-0" 5-6-21

SD

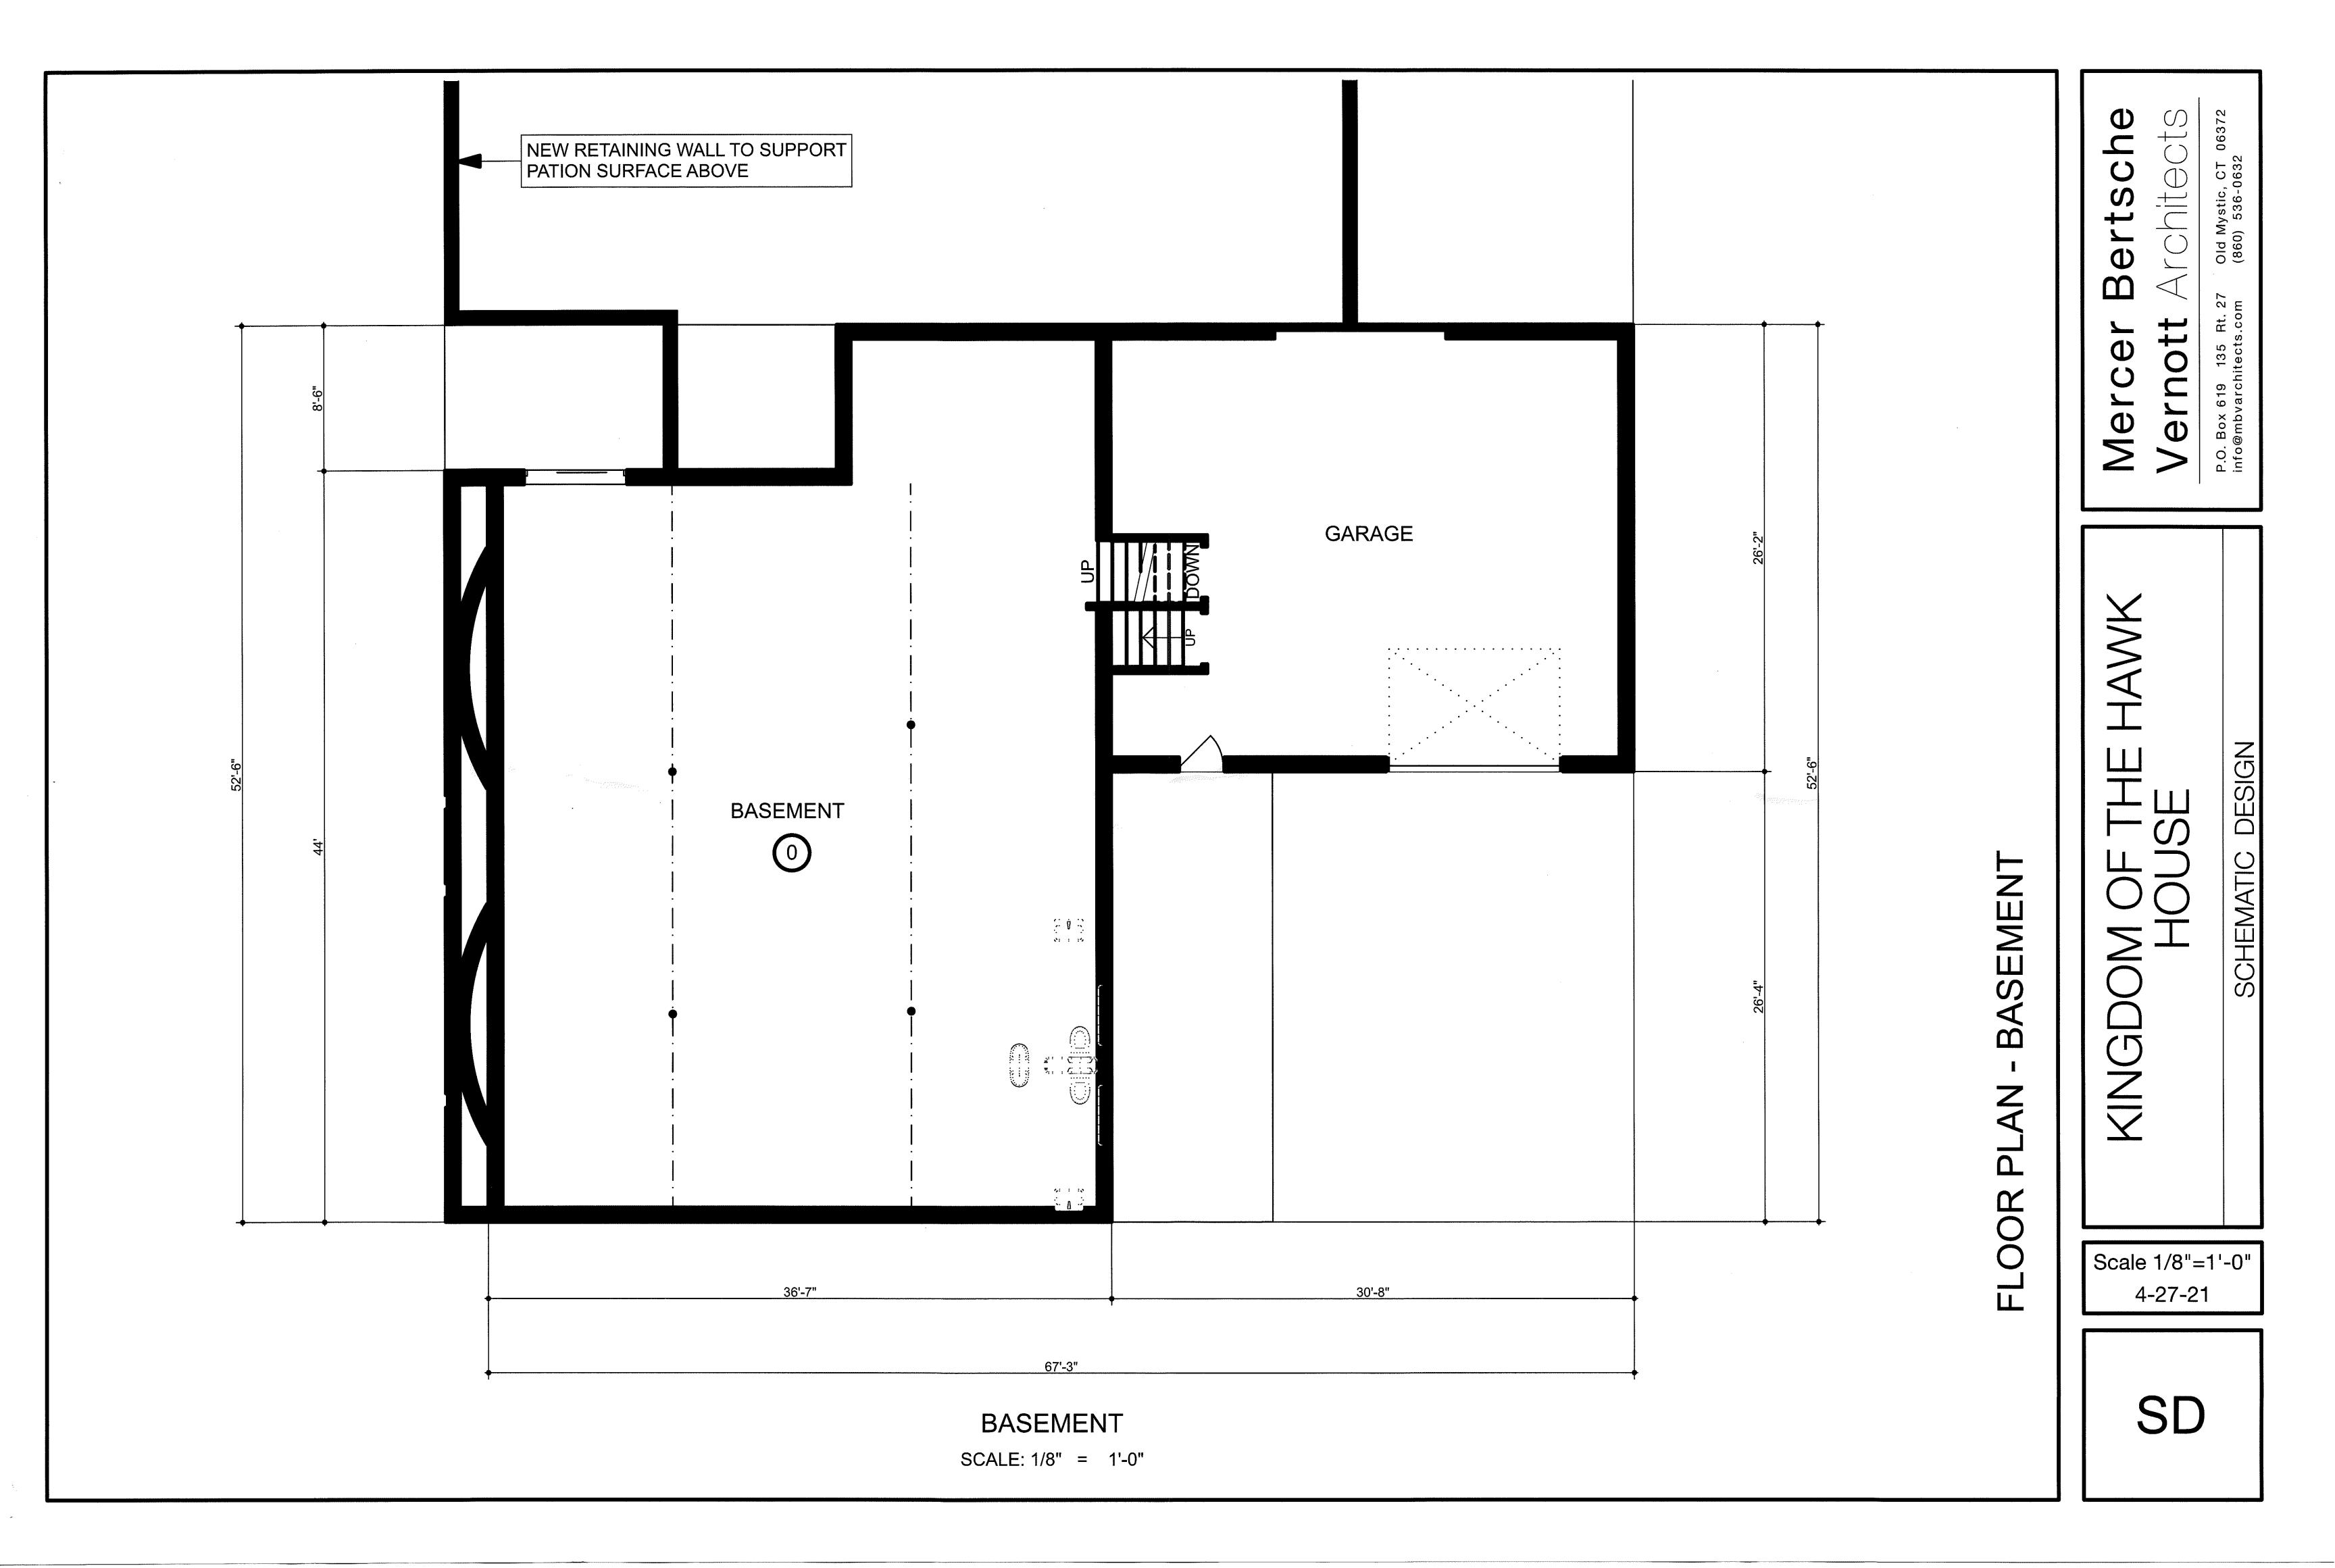

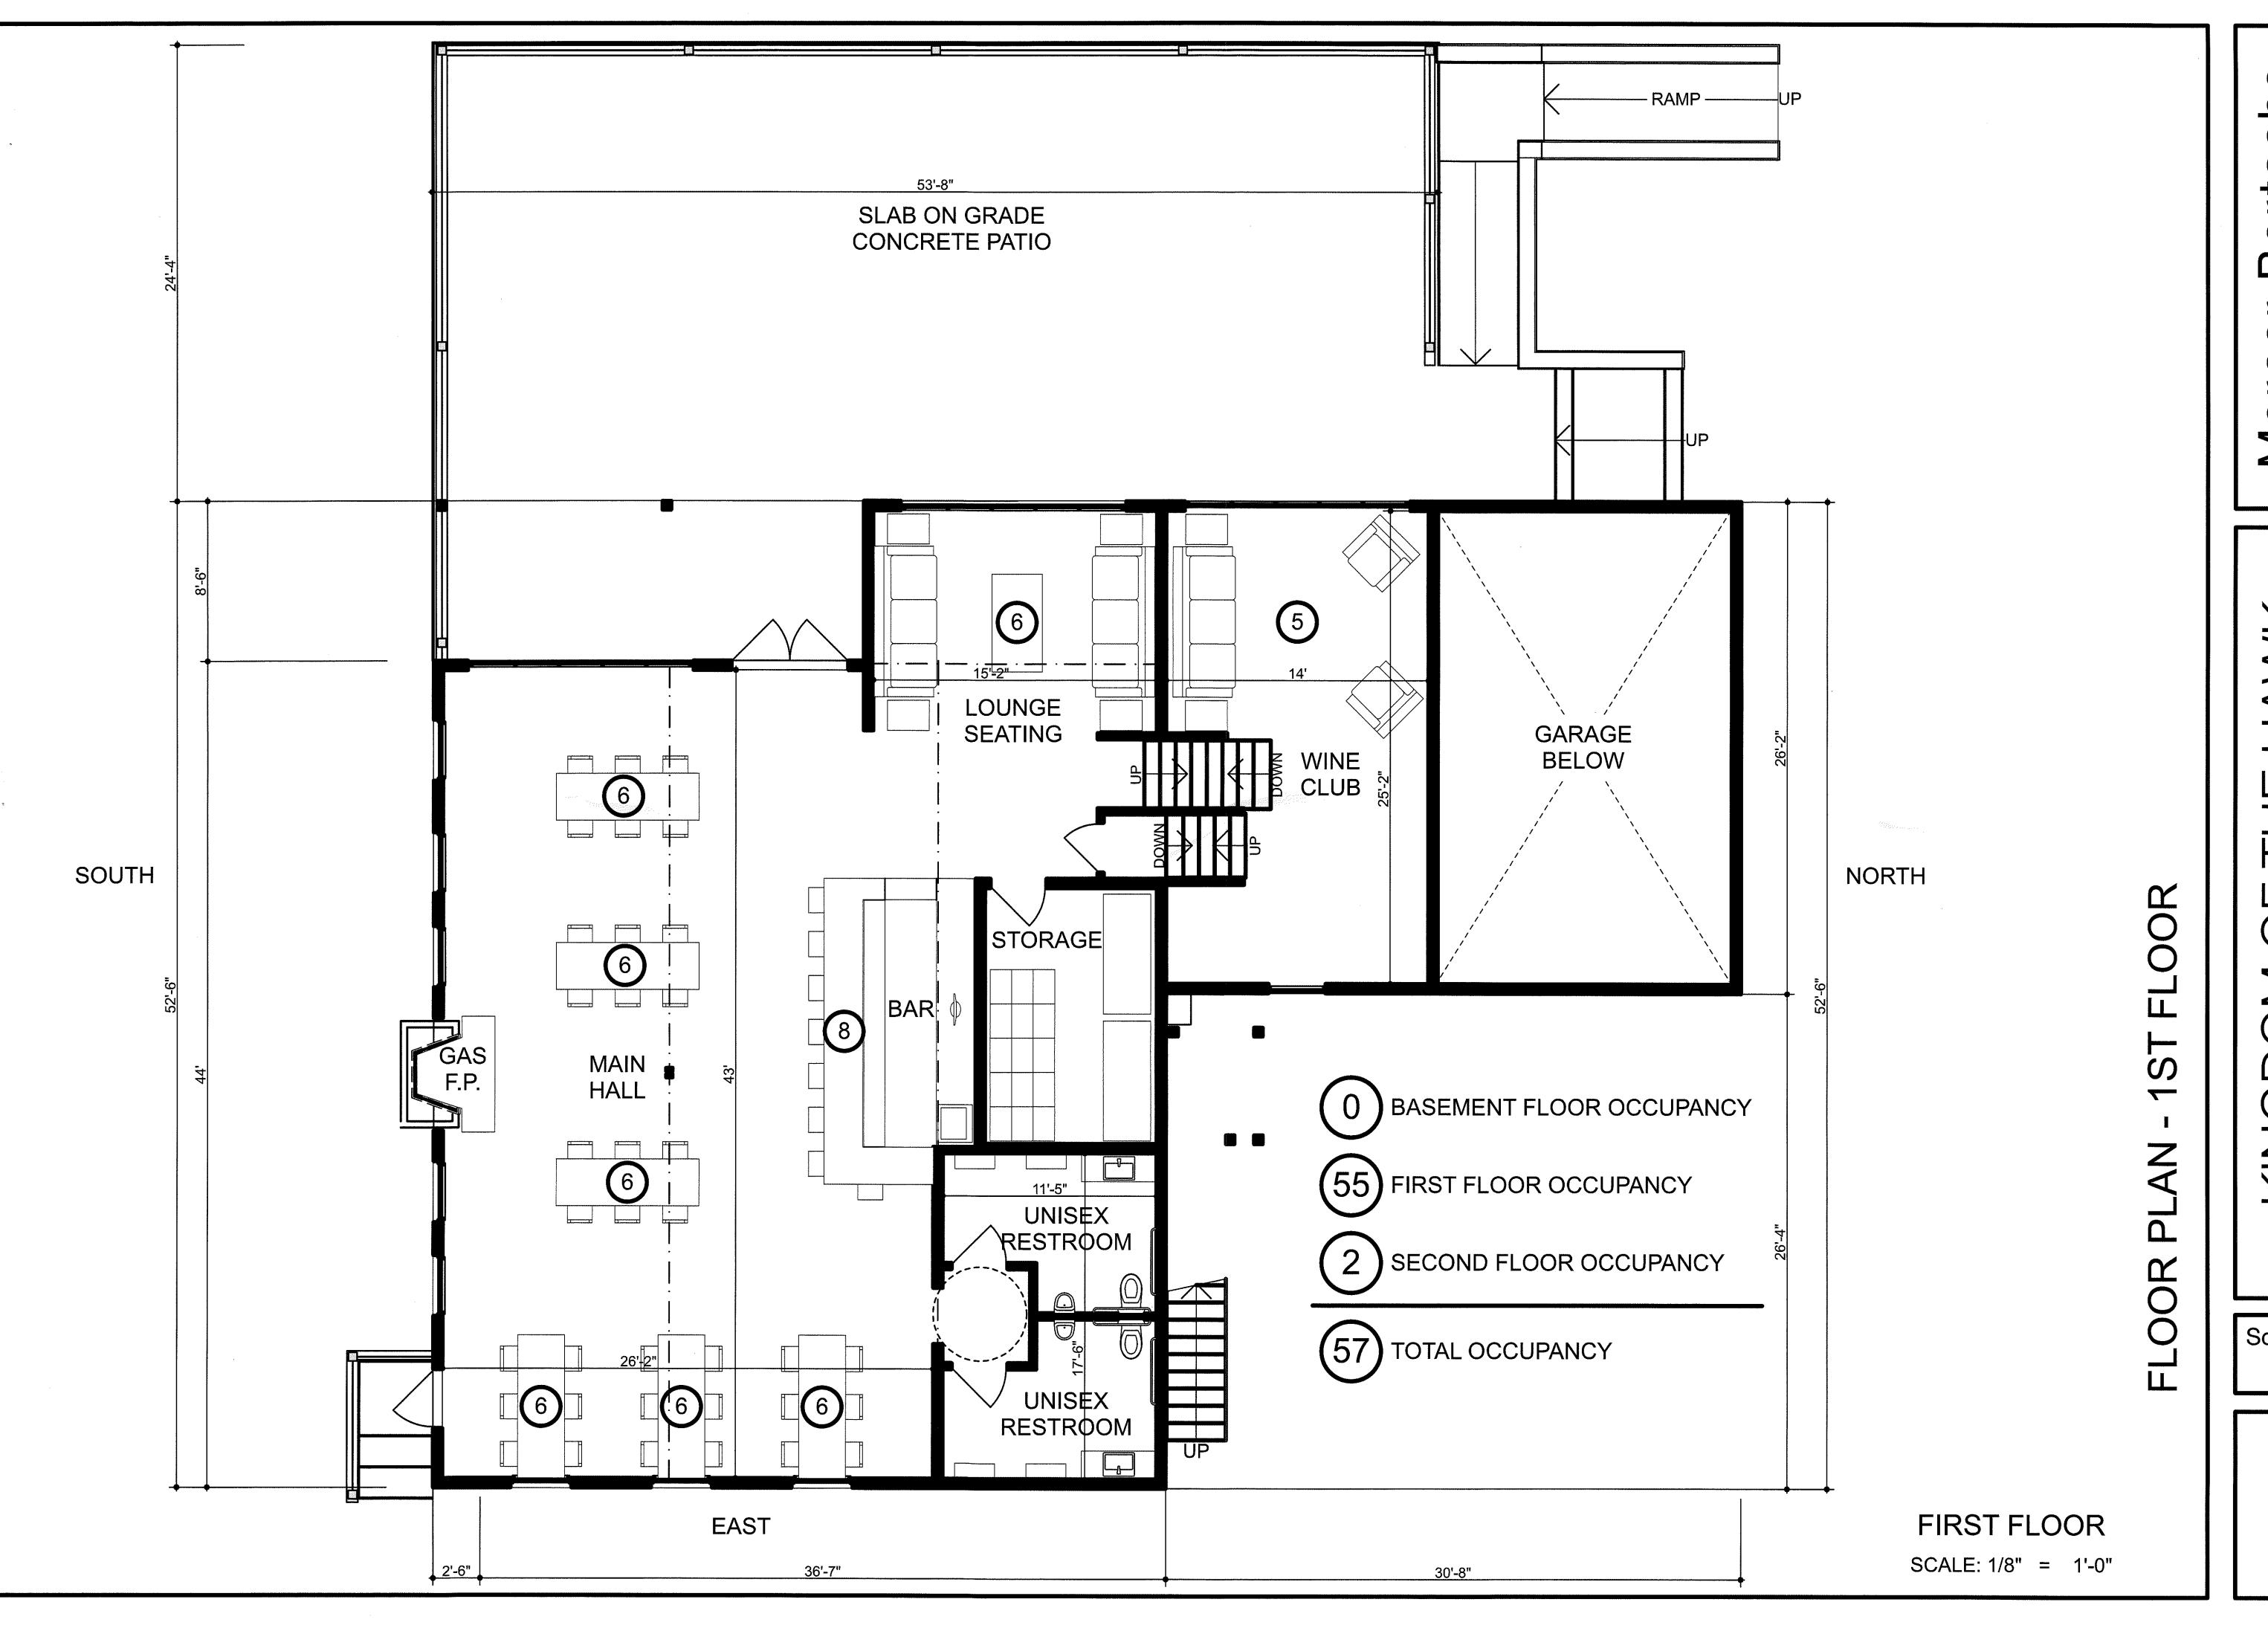

DOM OF THE TAWK
HOUSE

TOWN ZONING COMMISION SUBMISSION

Scale 1/8"=1'-0" 5-6-21

SD

FLOOR 2ND

TOWN ZONING COMMISION SUBMISSION Scale 1/8"=1'-0" 5-6-21

SD

SECOND FLOOR

SCALE: 1/8" = 1'-0"